


60.0MW SOLAR SYSTEM
TIERRA DEL SOL LLC

TIERRA DEL SOL SOLAR PROJECT
PLOT PLAN

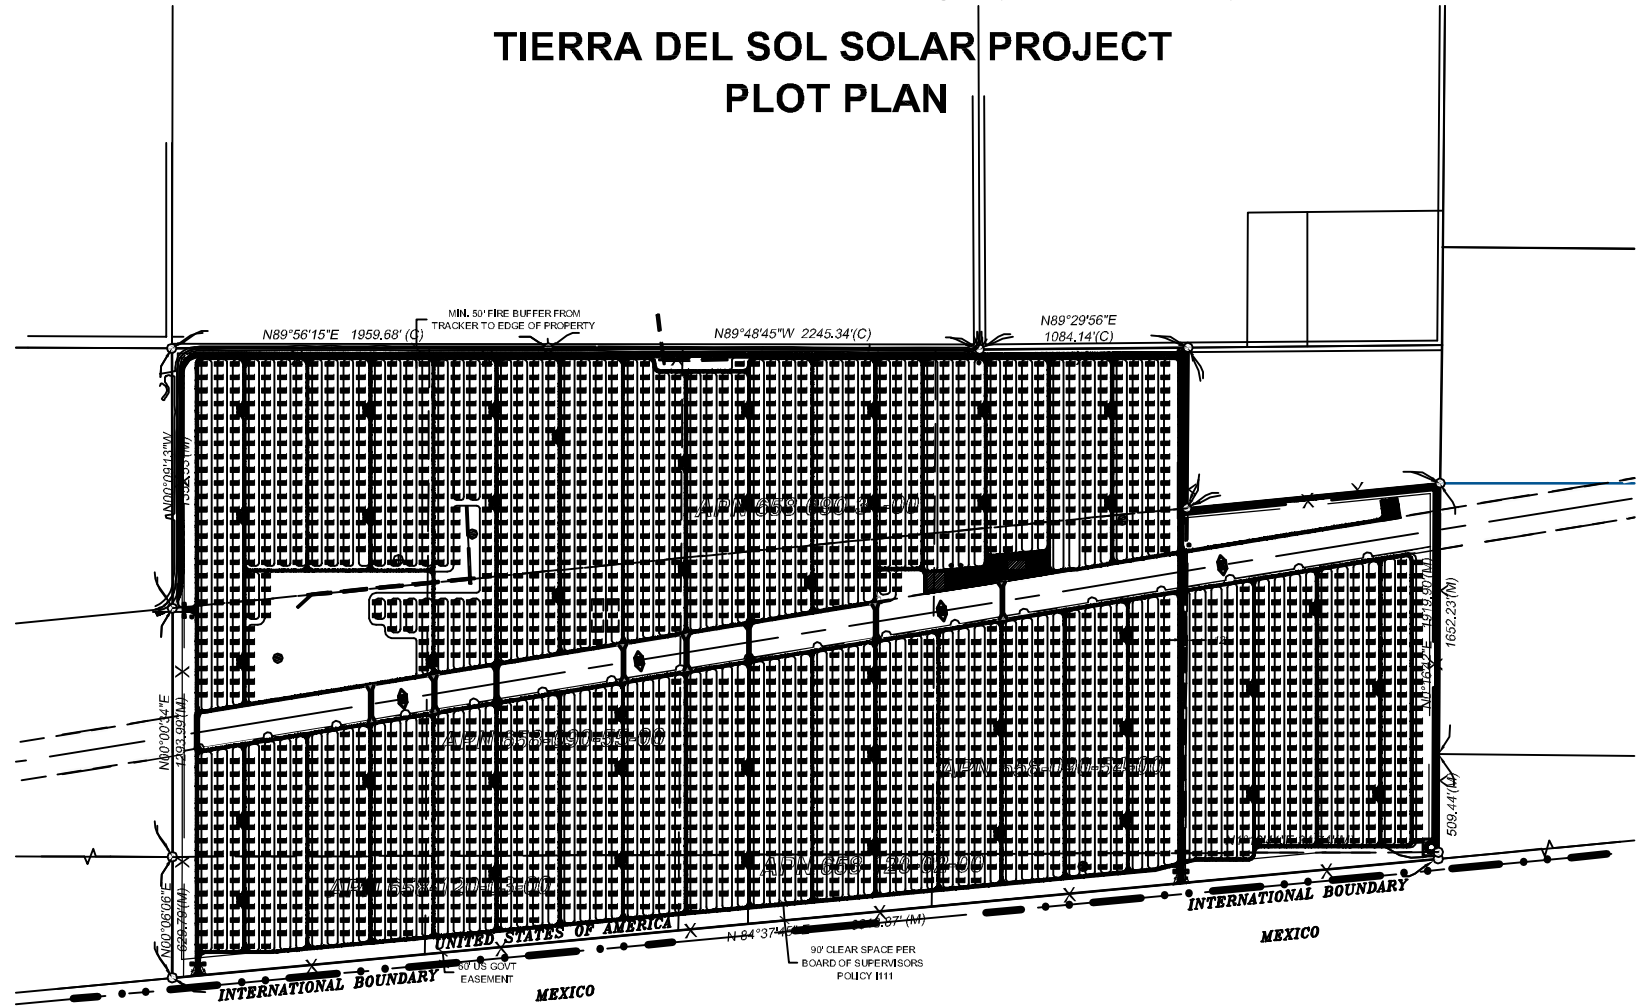

GENERAL NOTES:

- Each tracker assembly is approximately 48 FT wide with a maximum constructed height of 30 FT and spaced approximately 69 FT North to South; 82 FT East to West.
- Entrance to each gate will be from an improved driveway that shall be designed in accordance with the attached details on C-103 and equipped with an emergency key-operated override switch.
- At no point does the change of grade, along the primary access road, exceed 10%.
- Detailed cross sections of the roads are provided on the preliminary grading plan.
- All compaction requirements are listed on the preliminary grading plan.
- Turnaround shall be designed in accordance with County of San Diego Design Standard DS-06 for a county emergency fire apparatus.
- The project site is not located in a designated flood plain, therefore lines of inundation are not shown.
- Temporary and Permanent BMPs are shown on the preliminary grading plan.
- All coordinates shown are state plane coordinates based on CCS83, Zone 6 (2007.00 Epoch).
- All dimensions are shown in Decimal Feet.
- The solar related facilities (panels, electrical connections, transformer/inverter platform, O&M buildings, emergency generator, fencing, internal access and switchgear pad, etc.) shown on the plot plans may be relocated, (exclusive of the open space areas & undeveloped (future development area)) with the administrative approval of the director of dplu when found in conformance with the intent and conditions of the permit's approval. Transformer/inverter platform locations can be relocated/reconfigured without requirement of minor deviation.

ABBREVIATIONS:

- AC Alternating Current
ADT Average Daily Trips
BB Building Block
BMP Best Management Practice
- CEQA California Environmental Quality Act
CPV Concentrating Photovoltaic
CFA County Fire Authority
- DPLU County of San Diego, Department of Planning and Land Usage
DS Design Standard
- EIR Environmental Impact Report
EOP Edge of Pavement
- FT Feet
- IOD Irrevocable Offer of Dedication
- kV kilovolt
kW kilowatts
- MAX Maximum
MOU Memorandum of Understanding
MPA Major Use Permit Application
MUP Major Use Permit
MW Megawatts
- NTS Not to Scale
- PL Property Lines
- QTY Quantity
- RL Rural Land
ROW Right of Way
RPO Resource Protection Ordinance

SHEET INDEX

- C-100 LEGEND, SYMBOLS, ABBREVIATIONS & NOTES
C-101 PLOT PLAN
C-102 EASEMENT PLAN
C-103 ROAD DETAILS
C-104 ROAD DETAILS
- C-130 1.36 / 2.0 MW INVERTER BOX DESIGN
C-131 O&M BUILDING
C-132 FENCE ELEVATION DETAIL
C-133 TRACKER ELEVATION DETAIL
C-134 34.5kV OVERHEAD / WATER TANK ELEVATION DETAIL

RESERVED FOR COUNTY STAMPS

PARCEL ZONING SETBACK SCHEDULE


APN	SETBACK SCHEDULE DESIGNATION
658-090-31	D
658-090-55	D
658-120-03	D
658-090-54	D
658-120-02	D

* THIS PLAN IS EXEMPT FROM THE SETBACK SCHEDULE PURSUANT TO ZONING ORDINANCE 4813

COVERAGE TABLE

UNIT	# UNITS	ACRES / UNIT
TRACKER	2538	0.026
INVERTER	45	0.005
O&M	1	0.172
SUBSTATION	1	0.126
TOTAL ACRES =		67

VICINITY MAP

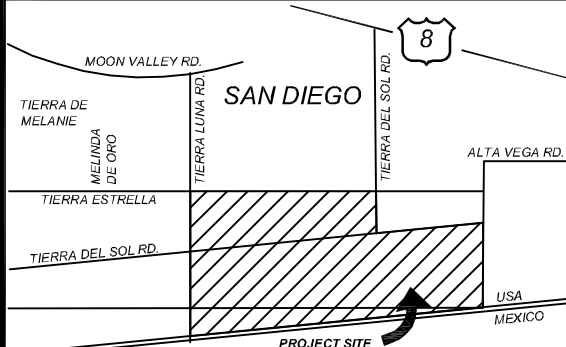

OWNER INFORMATION

NAME: Brown Family Trust, Brown & Reynolds Trust
ADDRESS: 1116 W. 7th Sreet PMB 158
CITY: Columbia
STATE: TN
ZIP: 38401
PHONE:
FAX:
EMAIL:

CONTACT INFORMATION

NAME: Pat Brown
ADDRESS: 4250 Executive Square, Suite 770
CITY: La Jolla
STATE: CA
ZIP: 92037
PHONE: (858) 652-4423
FAX:
EMAIL: patrick.brown@soitec.com

PARCEL INFORMATION

APN: 6580903100, 6580905500, 6581200300, 6581200200, 6580905400
SITE ADDRESS: 796 Tierra del Sol Road, Boulevard, CA 91905

PROJECT INFORMATION

EXISTING:
Relatively level land on the southern and central portions of the site with rolling rock and boulder covered hills on the northwestern portion. The site is minimally developed with unpaved roads.

PROPOSED:
60 Megawatt (MW) project, constructed in two phases, located on approximately 420 acres and includes the construction and operation of approximately 2538 Concentrated Photovoltaic (CPV) trackers configured into 45 (1.36 MW) BB that consist of 56 trackers with associated Inverter and Transformer.

PLOT PLAN INFORMATION

CPV System Summary

Approx. Number of Trackers:	2538
Tracker per BB:	56
Number of BB:	45
Total AC Capacity (MWs):	Approx. 60MW
Inverter Skid AC Capacity (MWs):	1.36 / 2.0
Number of 1.36 MW Inverter Skids:	45
Total Lot Size (Acres):	Approx. 420
Estimated Disturbed Acreage:	420
Coverage Ratio:	16%


SHEET TITLE

LEGEND, SYMBOLS
ABBREVIATIONS
& NOTES

SHEET NUMBER REV.

C-100

0

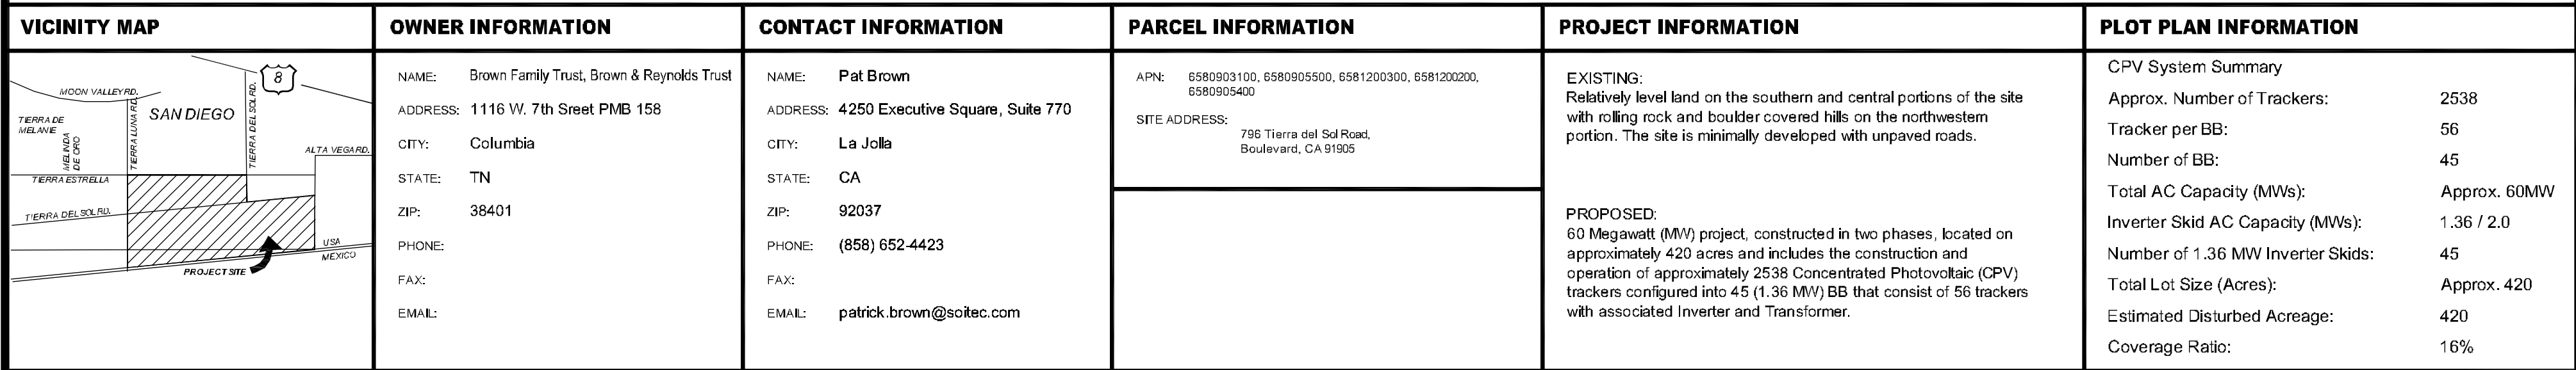

EXCEPTIONS AND EXCLUSIONS

- 15

AN EASEMENT FOR PUBLIC UTILITIES AND INCIDENTAL PURPOSES, RECORDED FEBRUARY 28, 1979 AS INSTRUMENT NO. 79-085974 OF OFFICIAL RECORDS.
- 16

AN EASEMENT FOR PUBLIC UTILITIES AND INCIDENTAL PURPOSES, RECORDED FEBRUARY 28, 1979 AS INSTRUMENT NO. 79-085975 OF OFFICIAL RECORDS.
- 17

AN EASEMENT FOR PUBLIC UTILITIES AND INCIDENTAL PURPOSES, RECORDED MAY 6, 1980 AS INSTRUMENT NO. 80-151392 OF OFFICIAL RECORDS.
- 18

AN EASEMENT FOR PUBLIC UTILITIES AND INCIDENTAL PURPOSES, RECORDED JANUARY 21, 1982 AS INSTRUMENT NO. 82-017128 OF OFFICIAL RECORDS.
- 19

AN EASEMENT FOR PUBLIC UTILITIES AND INCIDENTAL PURPOSES, RECORDED JUNE 18, 1982 AS INSTRUMENT NO. 82-187732 OF OFFICIAL RECORDS.

EASEMENT LEGEND

- 10

AN EASEMENT FOR PUBLIC UTILITIES AND INCIDENTAL PURPOSES, RECORDED MAY 6, 1980 AS INSTRUMENT NO. 80-151391 OF OFFICIAL RECORDS.
- 11

AN EASEMENT FOR PUBLIC UTILITIES AND INCIDENTAL PURPOSES, RECORDED NOVEMBER 16, 1983 AS INSTRUMENT NO. 83-416580 OF OFFICIAL RECORDS.
- 13

THE TERMS, PROVISIONS AND EASEMENT(S) CONTAINED IN THE DOCUMENT ENTITLED "EASEMENT GENERAL" RECORDED FEBRUARY 1, 1995 AS INSTRUMENT NO. 1995-0044962 OF OFFICIAL RECORDS.
- 13




EXCEPTIONS AND EXCLUSIONS ARE THE SAME AS THAT SHOWN ON COMMITMENT NO. NCS-474346-SD SEPTEMBER 09, 2011.
- 13

EXCEPTIONS AND EXCLUSIONS ARE THE SAME AS THAT SHOWN ON COMMITMENT NCS-505191-SD DATED SEPTEMBER 15, 2011.


LEGEND:

- EASEMENT
- PROPERTY LINE
- SECURITY FENCE
- EXISTING WATER WELLS, NTS TO BE CAPPED OR DESTROYED
- ⊕


PROPOSED WELL LOCATIONS, NTS
- INTERNATIONAL BOUNDARY

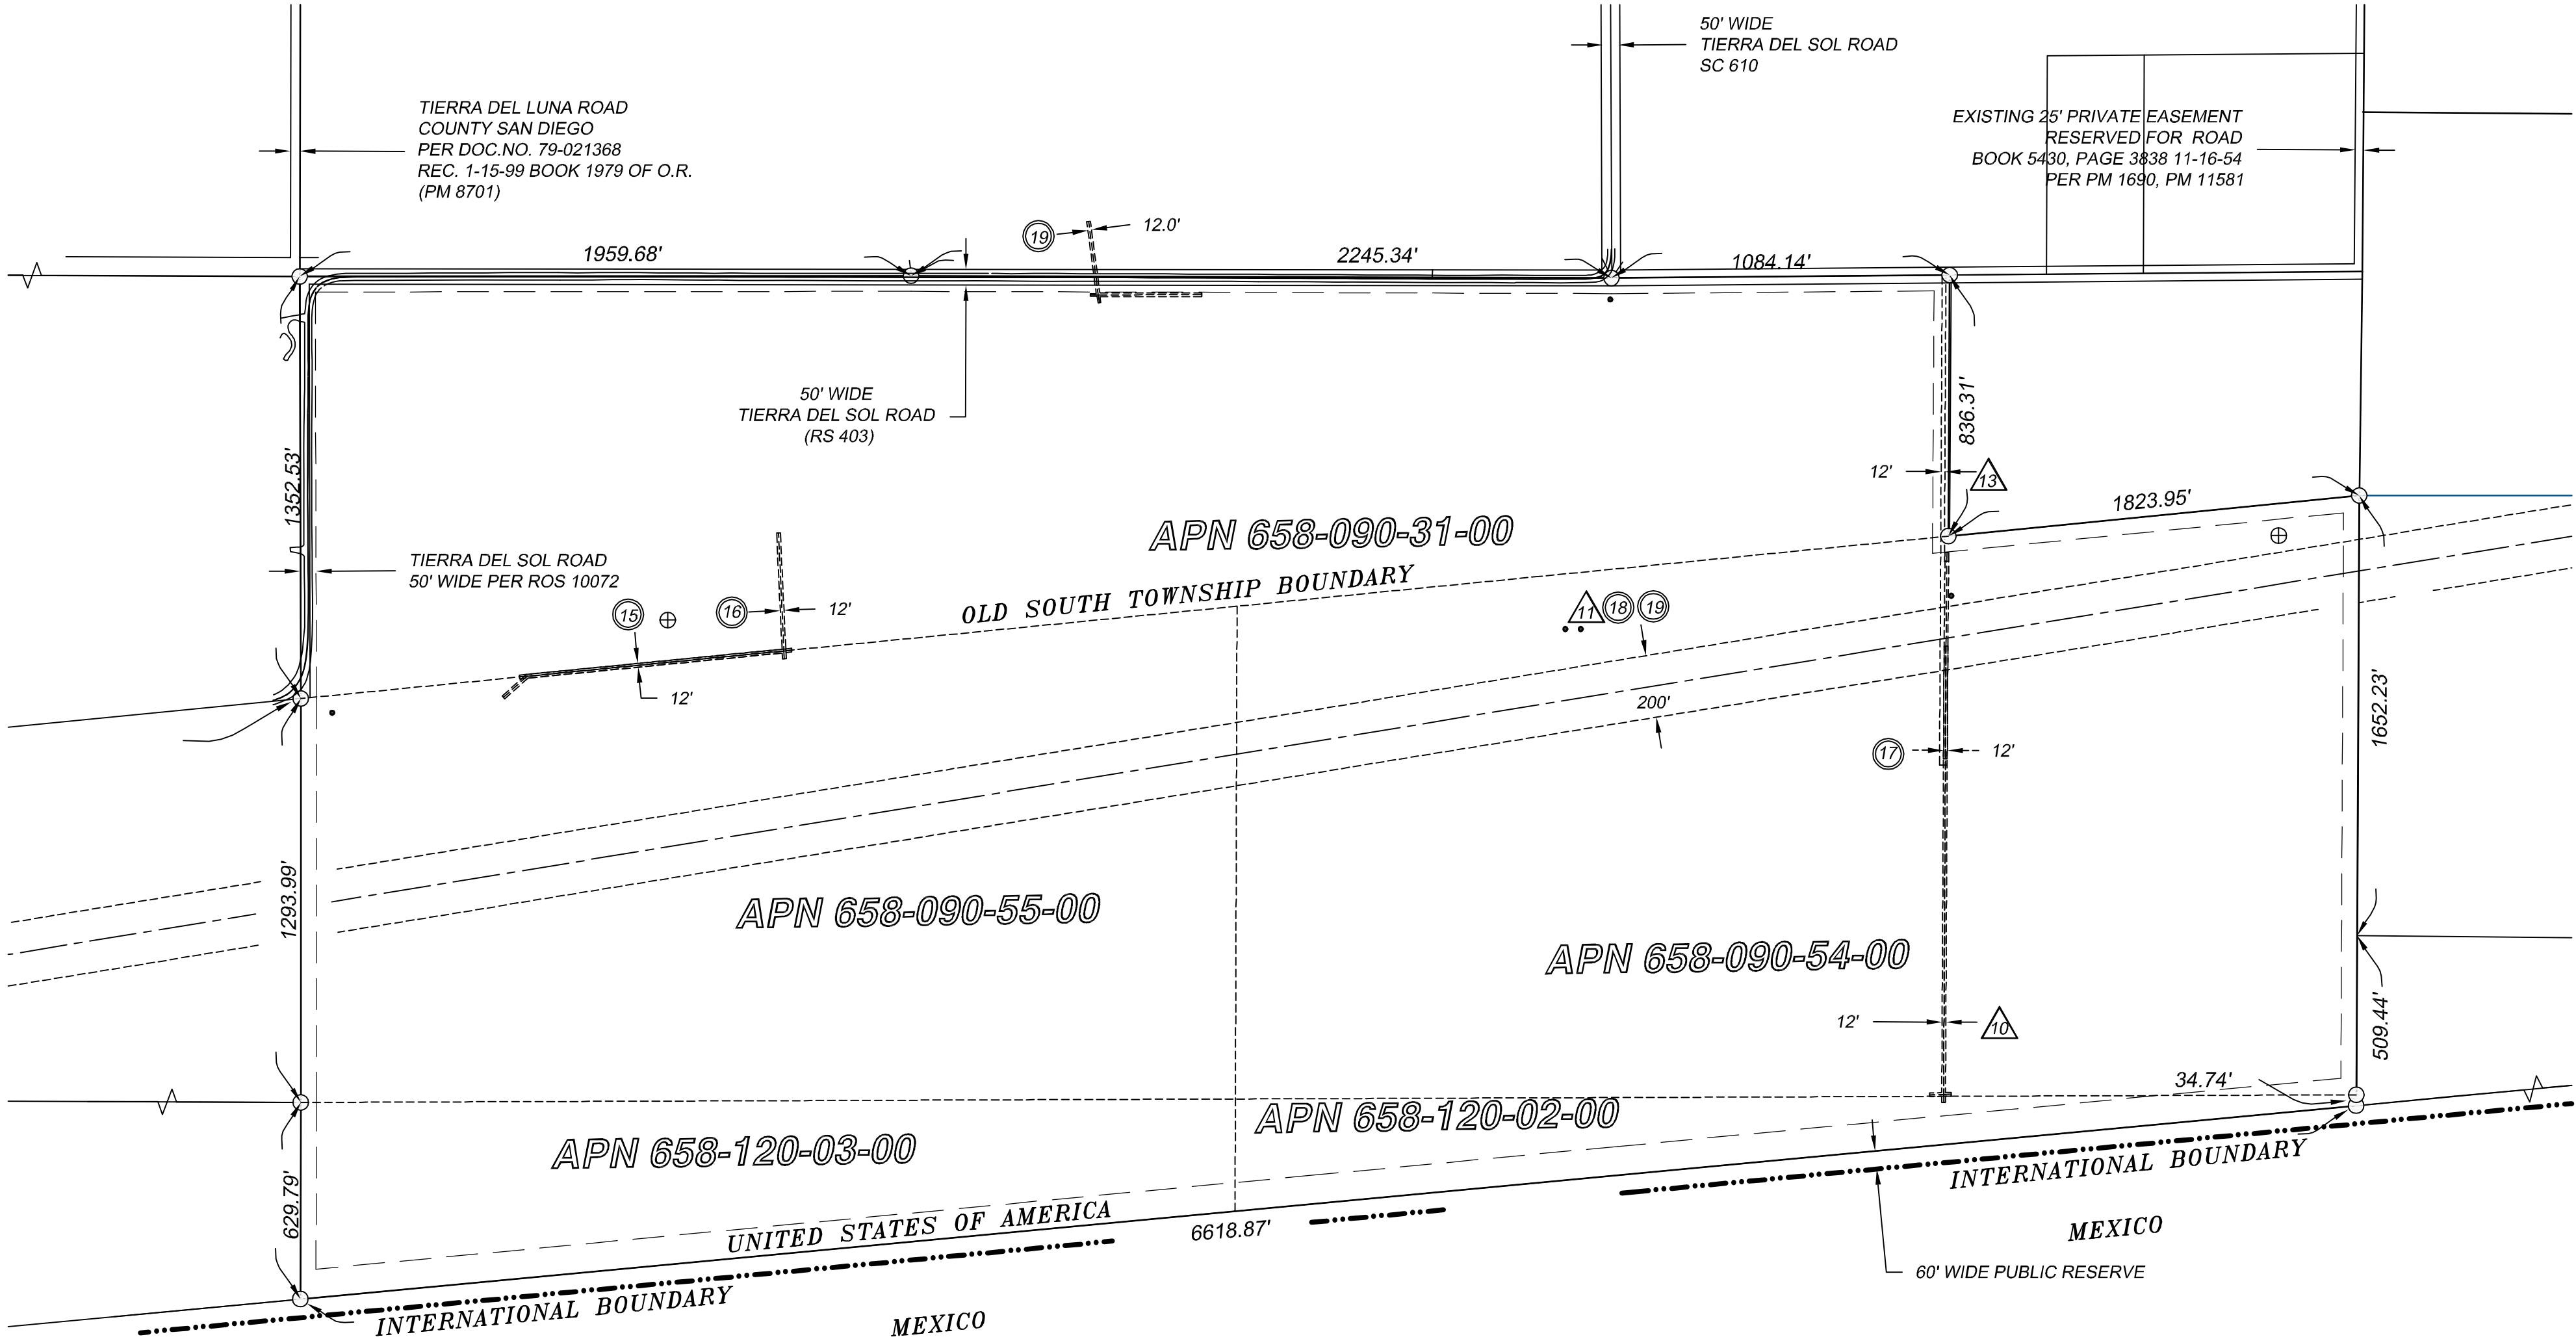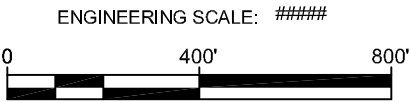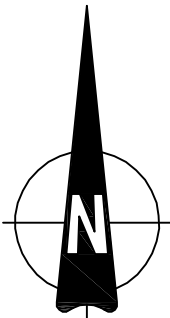


VICINITY MAP	OWNER INFORMATION	CONTACT INFORMATION	PARCEL INFORMATION	PROJECT INFORMATION	PLOT PLAN INFORMATION	SHEET TITLE
	NAME: Brown Family Trust, Brown & Reynolds Trust	NAME: Pat Brown	APN: 6580903100, 6580905500, 6581200300, 6581200200, 6580905400	EXISTING: Relatively level land on the southern and central portions of the site with rolling rock and boulder covered hills on the northwestern portion. The site is minimally developed with unpaved roads.	CPV System Summary	EASEMENT PLAN
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	STATE: TN	STATE: CA			Number of BB: 45	
	ZIP: 38401	ZIP: 92037			Total AC Capacity (MWs): Approx. 60MW	C-102
	PHONE:	PHONE: (858) 652-4423			Inverter Skid AC Capacity (MWs): 1.36 / 2.0	
	FAX:	FAX:			Number of 1.36 MW Inverter Skids: 45	0
	EMAIL:	EMAIL: patrick.brown@soitec.com			Total Lot Size (Acres): Approx. 420	
					Estimated Disturbed Acreage: 420	
					Coverage Ratio: 16%	

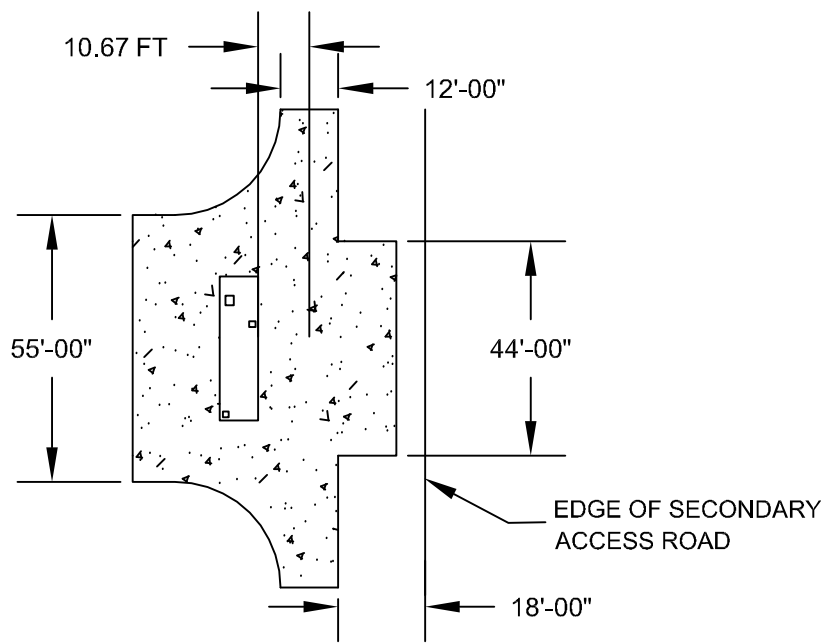


1 | **DETAIL - INVERTER PAD**
SEE DETAIL 1 FOR MATERIAL COMPACTION NTS

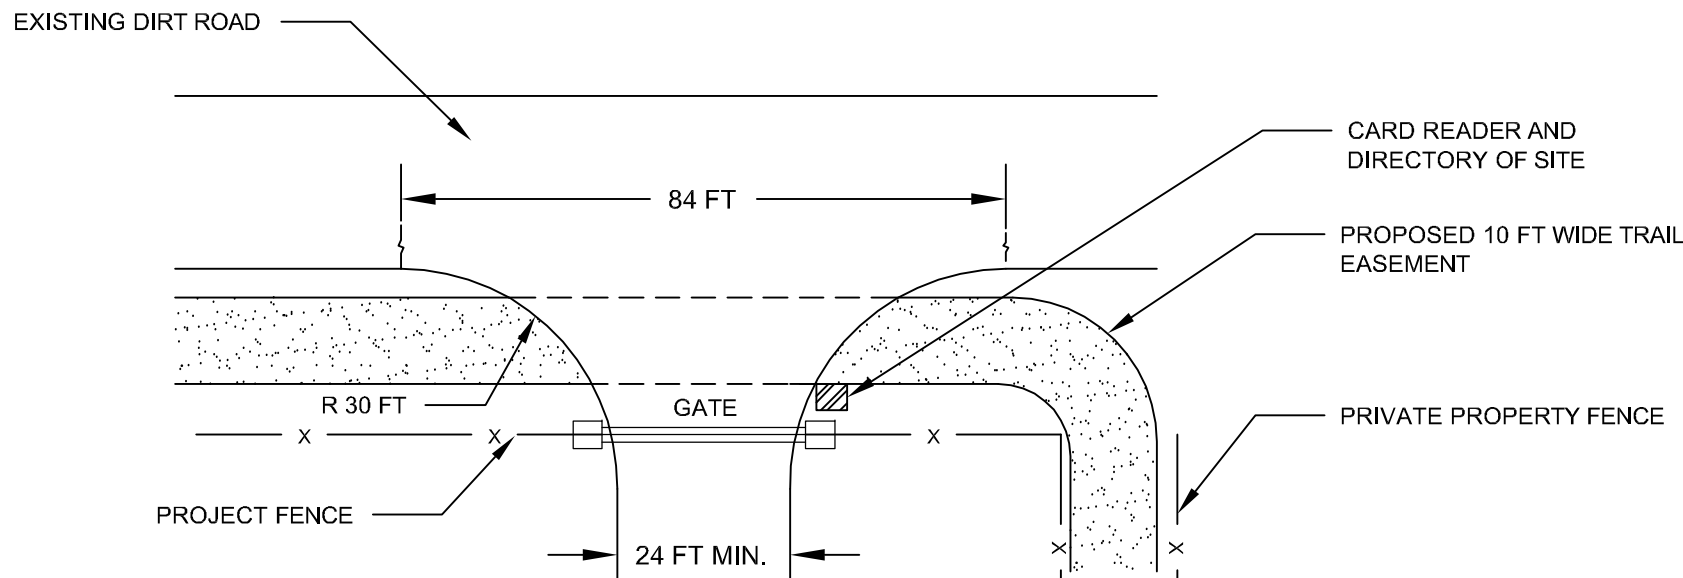


2 | **DETAIL-ENTRANCE**
NO EXISTING CURB ON TIERRA DEL SOL ROAD.
STORM WATER TO STREET FLOW TO EXISTING DRAINAGE FEATURES.
DRIVEWAY WILL BE CONSTRUCTED PER DS-7 STANDARD. NTS

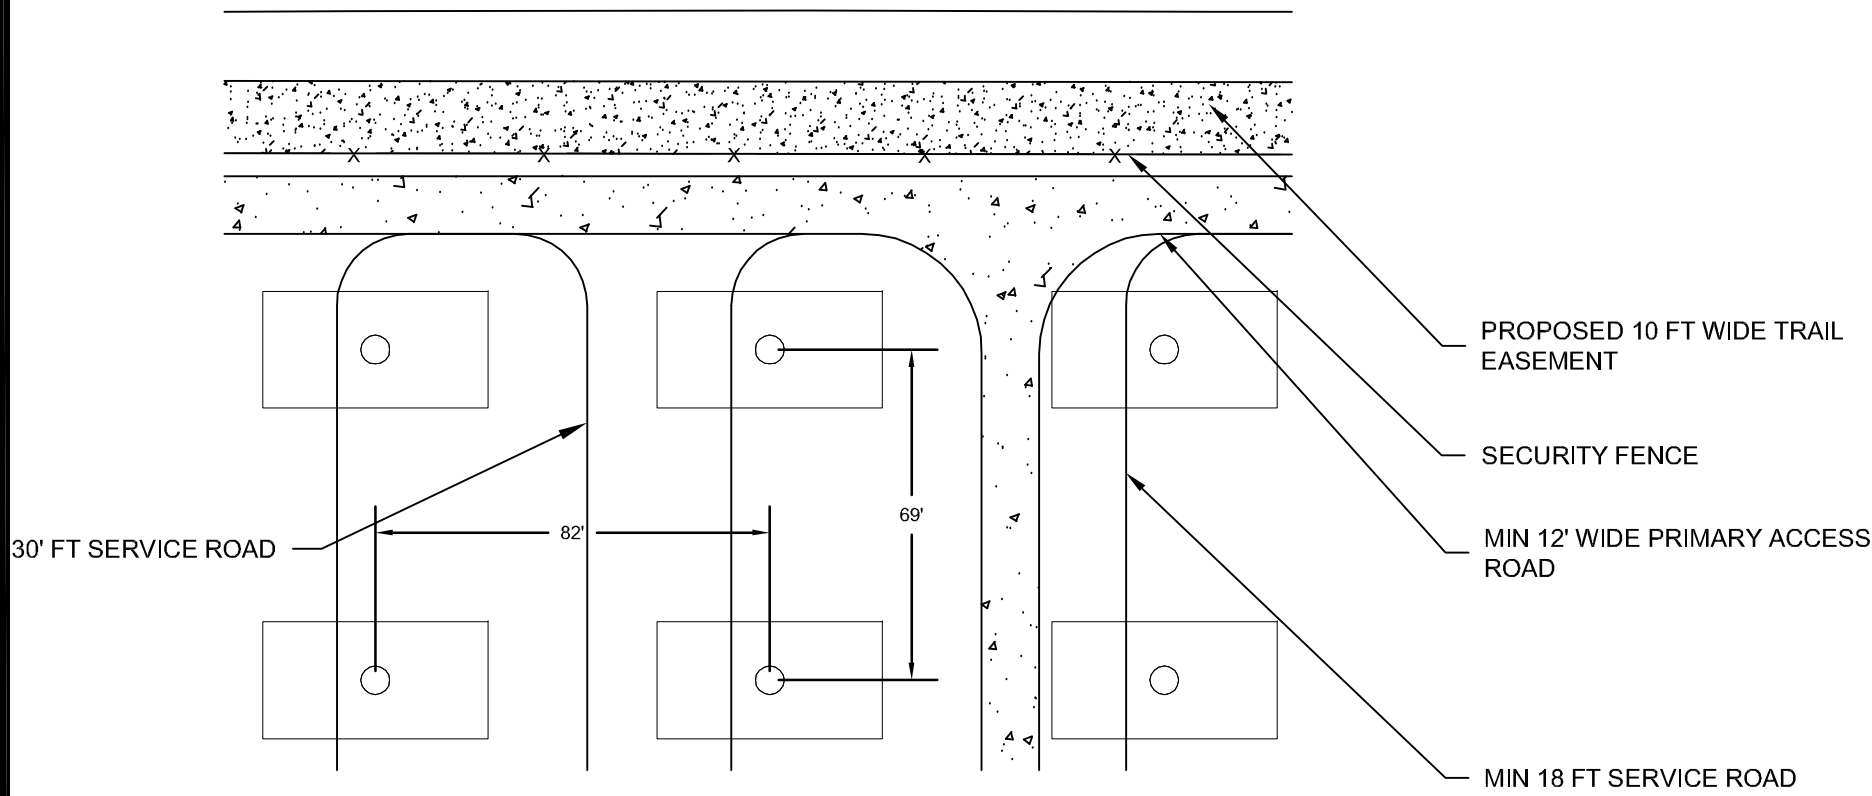

3 | **DETAIL - ROAD LAYOUT**
NTS

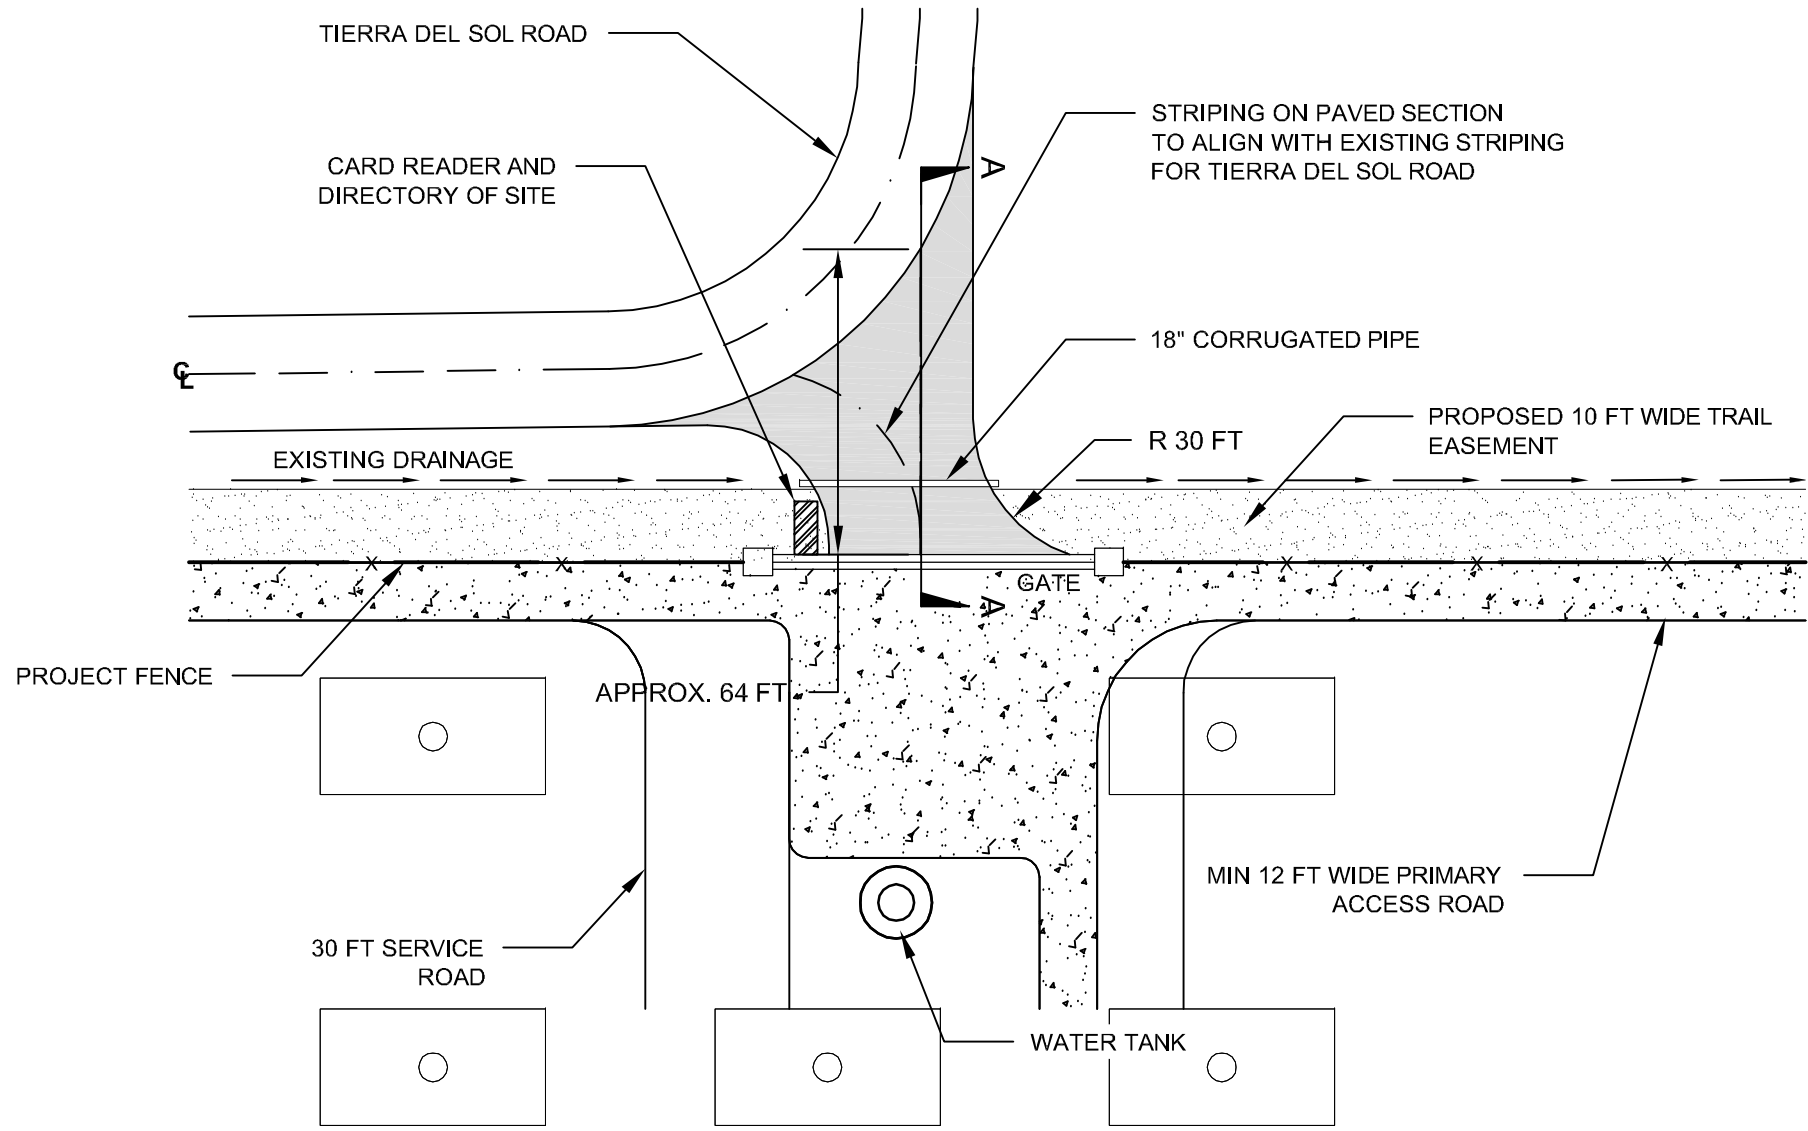

4 | **DETAIL DRIVEWAY ENTRANCE**
NO EXISTING CURB ON TIERRA DEL SOL ROAD.
STORM WATER TO SHEET FLOW TO EXISTING DRAINAGE FEATURES.
DRIVEWAY WILL BE CONSTRUCTED PER DS-7 STANDARD. NTS

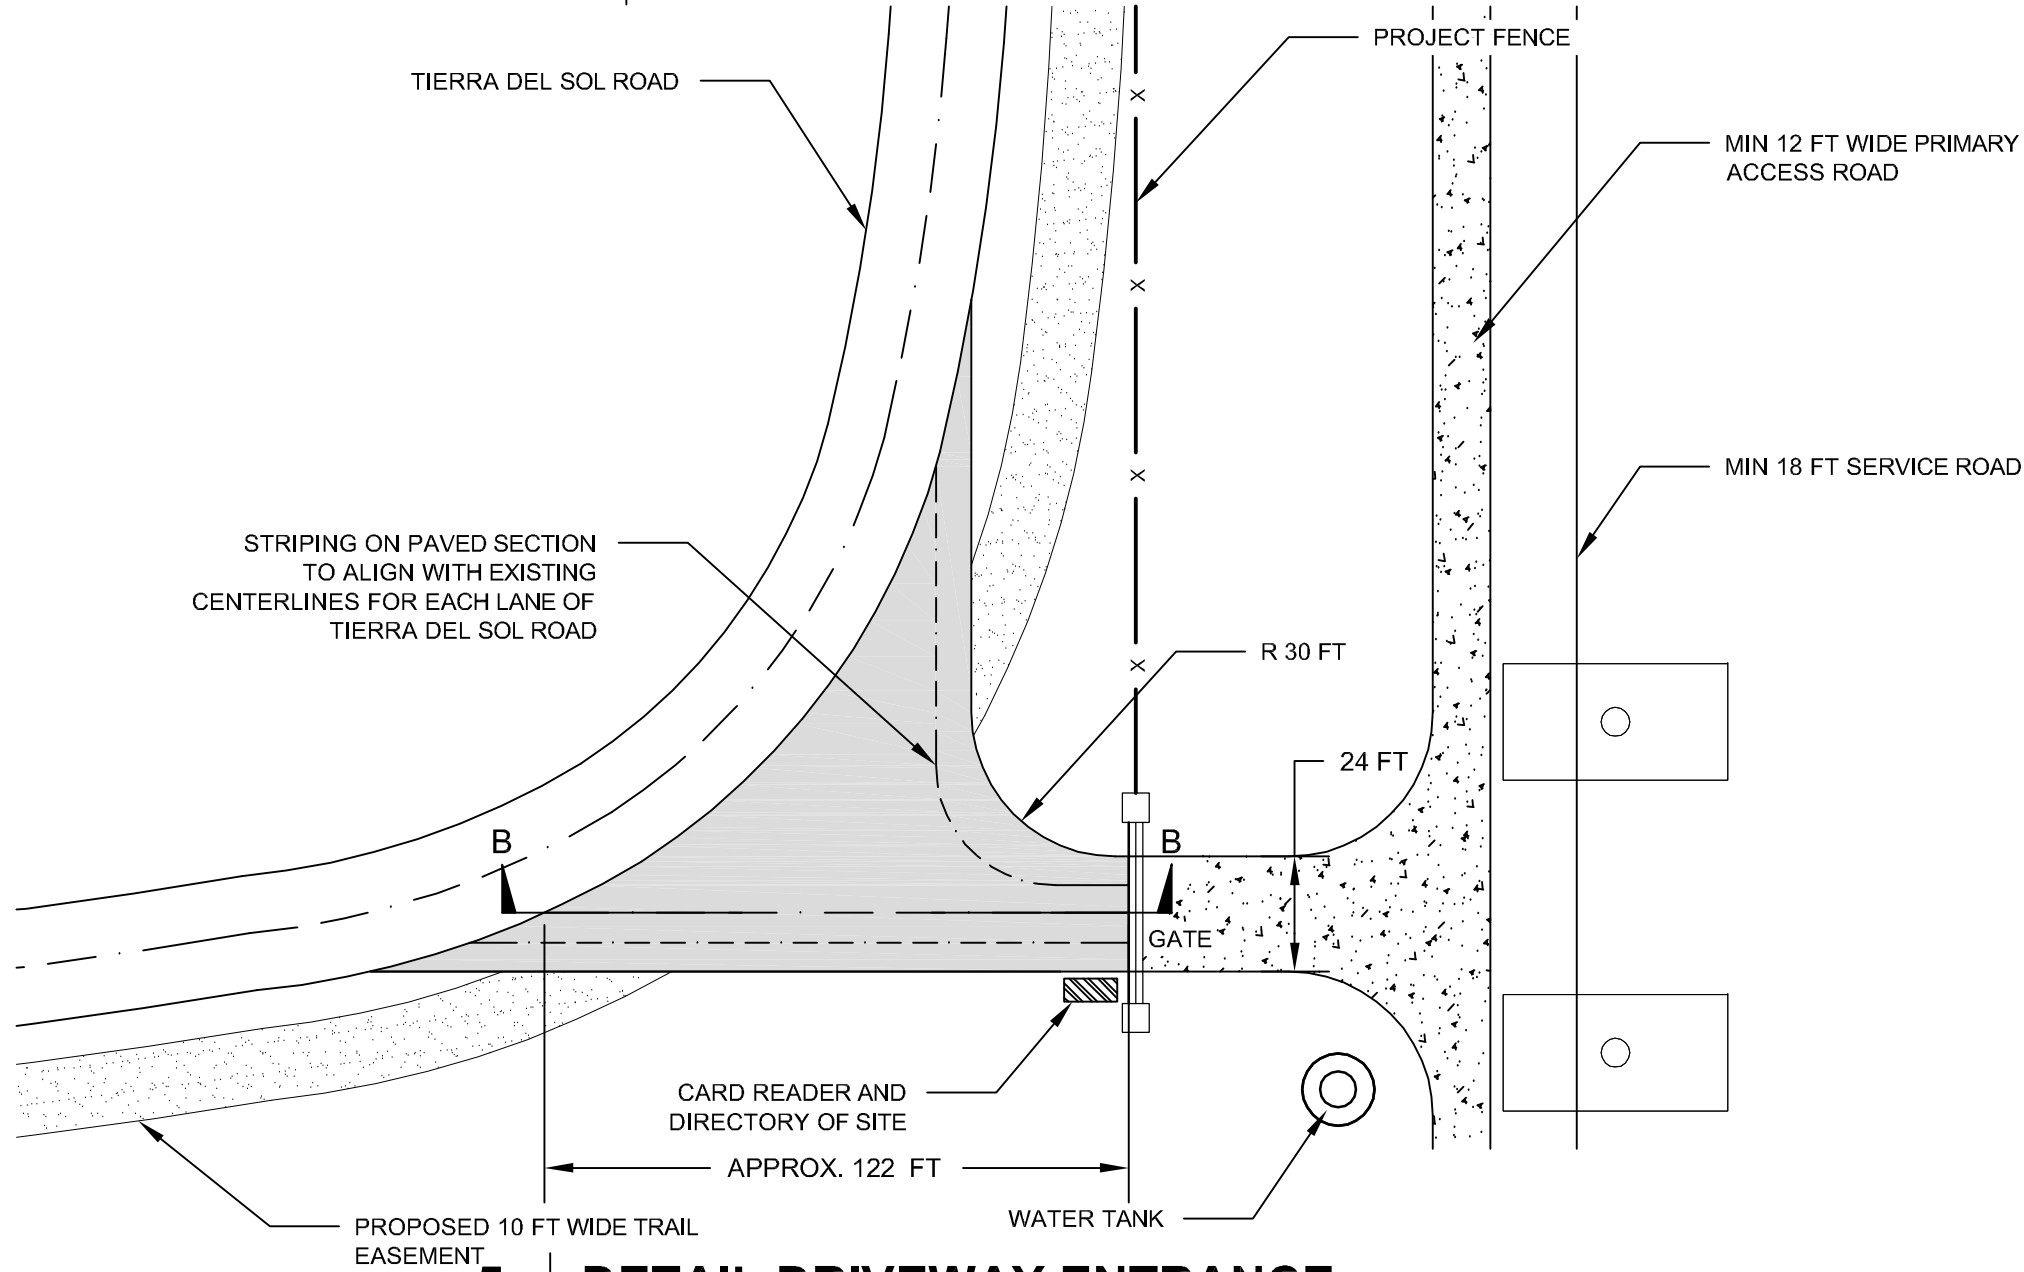

5 | **DETAIL DRIVEWAY ENTRANCE**
NO EXISTING CURB ON TIERRA DEL SOL ROAD.
STORM WATER TO SHEET FLOW TO EXISTING DRAINAGE FEATURES.
DRIVEWAY WILL BE CONSTRUCTED PER DS-7 STANDARD. NTS

AECOM

DESIGNER

AECOM

AECOM TECHINCAL SERVICES, INC
440 Stevens Avenue, Suite 250
Solana Beach, CA 98075
858.947.7144 tel 858.947.7145 fax
www.aecom.com


CLIENT



Soitec Solar Development, LLC

4250 Executive Square, Suite 770
San Diego, CA 92037-9178

VICINITY MAP

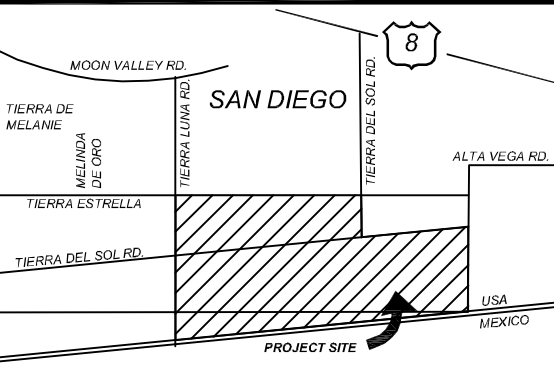

OWNER INFORMATION

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ADDRESS: 1116 W. 7th Sreet PMB 158
CITY: Columbia
STATE: TN
ZIP: 38401
PHONE:
FAX:
EMAIL:

CONTACT INFORMATION

NAME: Pat Brown
ADDRESS: 4250 Executive Square, Suite 770
CITY: La Jolla
STATE: CA
ZIP: 92037
PHONE: (858) 652-4423
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PLOT PLAN INFORMATION

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Coverage Ratio:	16%

SHEET TITLE


ROAD DETAILS

SHEET NUMBER

REV.

C-103

0

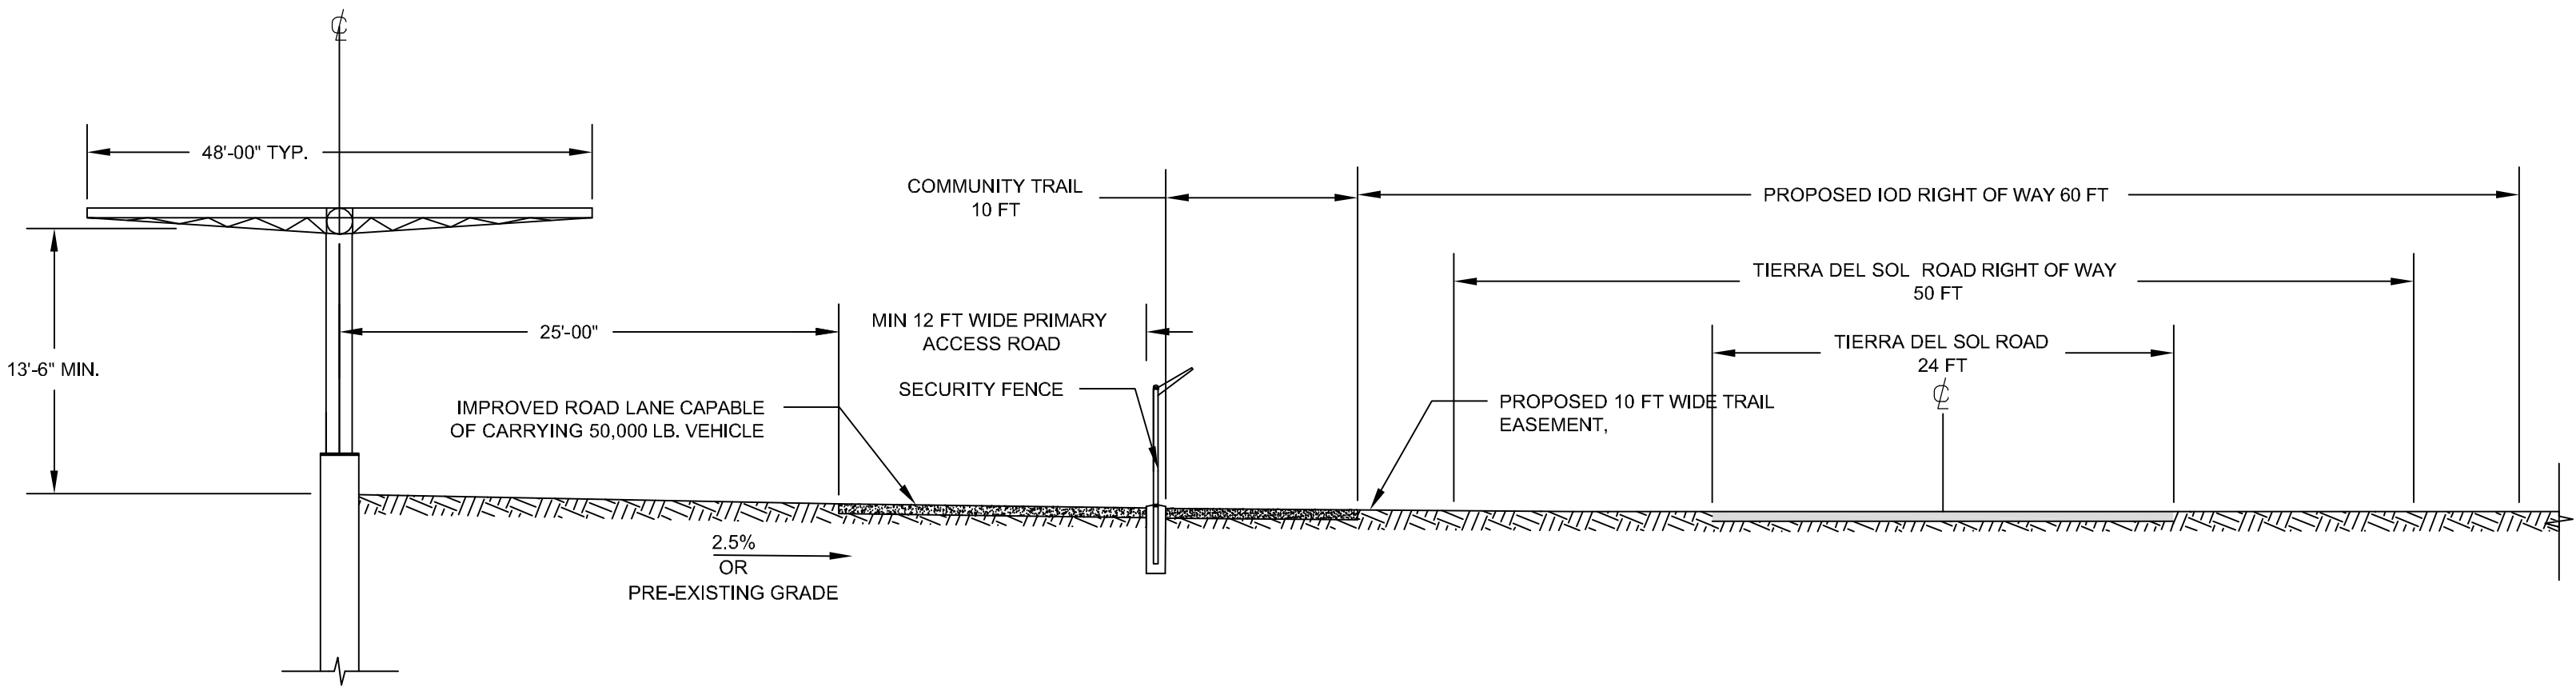

6 | TYPICAL CROSS SECTION

NTS

AECOM

DESIGNER

AECOM

AECOM TECHINCAL SERVICES, INC
440 Stevens Avenue, Suite 250
Solana Beach, CA 98075
858.947.7144 tel 858.947.7145 fax
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CLIENT



Soitec Solar Development, LLC




4250 Executive Square, Suite 770
San Diego, CA 92037-9178

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	STATE: TN	STATE: CA			Number of BB: 45	REV.
	ZIP: 38401	ZIP: 92037			Total AC Capacity (MWs): Approx. 60MW	C-104
	PHONE:	PHONE: (858) 652-4423			Inverter Skid AC Capacity (MWs): 1.36 / 2.0	
	FAX:	FAX:			Number of 1.36 MW Inverter Skids: 45	0
	EMAIL:	EMAIL: patrick.brown@soitec.com			Total Lot Size (Acres): Approx. 420	
					Estimated Disturbed Acreage: 420	
					Coverage Ratio: 16%	

INVERTER DIMENSION

INVERTER RATING (MW)	DIMENSION (FT)		
	"A"	"B"	"C"
1.36	25	10	12
2.00	40	10	12

REV	ITEM	QTY	DESCRIPTION
	1	1	PRECAST SHELTER
	2		PRIMARY RE-COMBINER BOX, 16 X 150A MCCC (QTY OF 2 OR 3)
	3		XC 680 INVERTER (QTY OF 2 OR 3)
	4	1	SCADA
	5	1	POWER PANEL
	6	1	TRANSFORMER
	7	1	STEEL SKID
	8	3	INTAKE AIR FANS
	9	3	EXHAUST LOUVERS

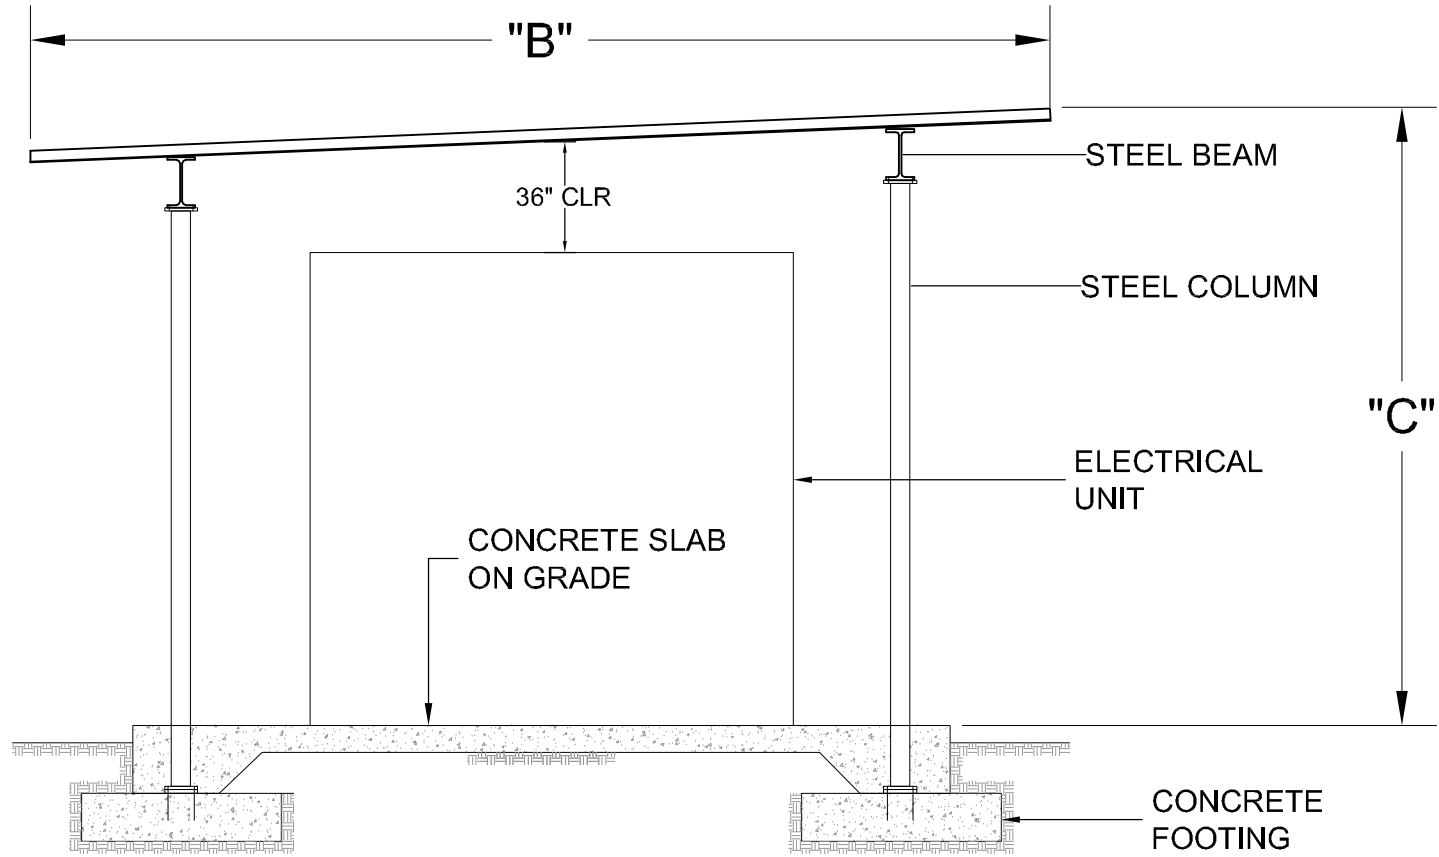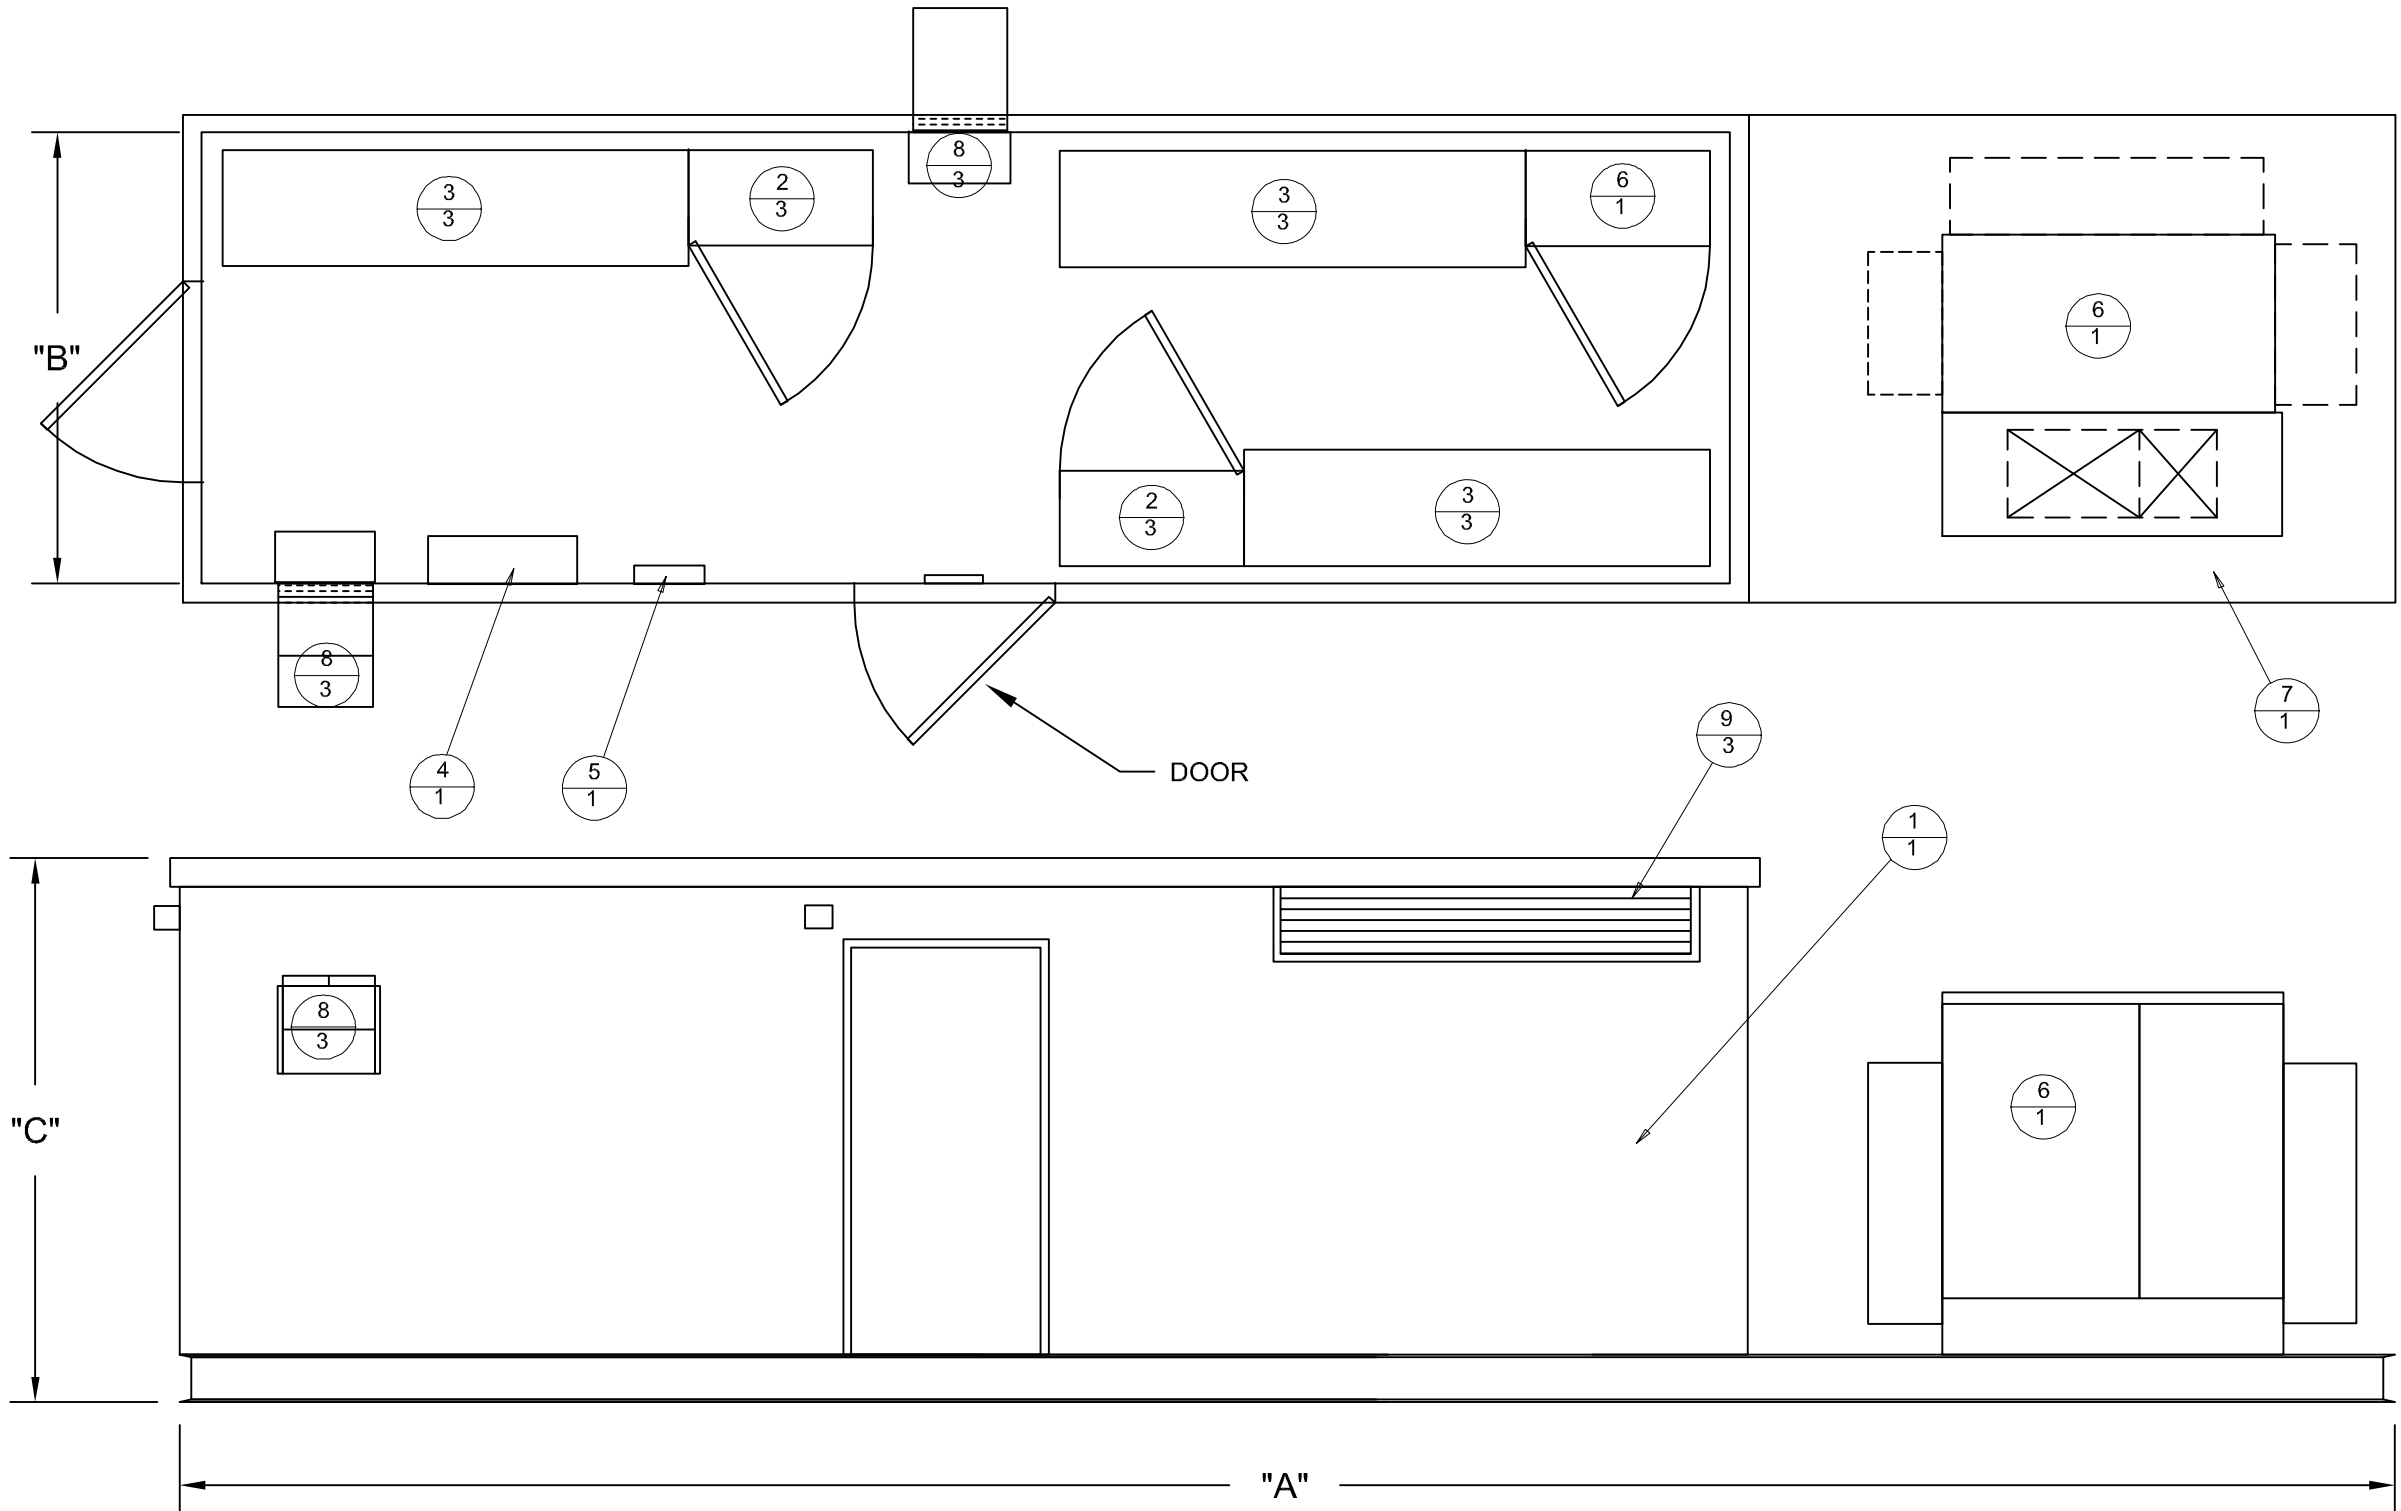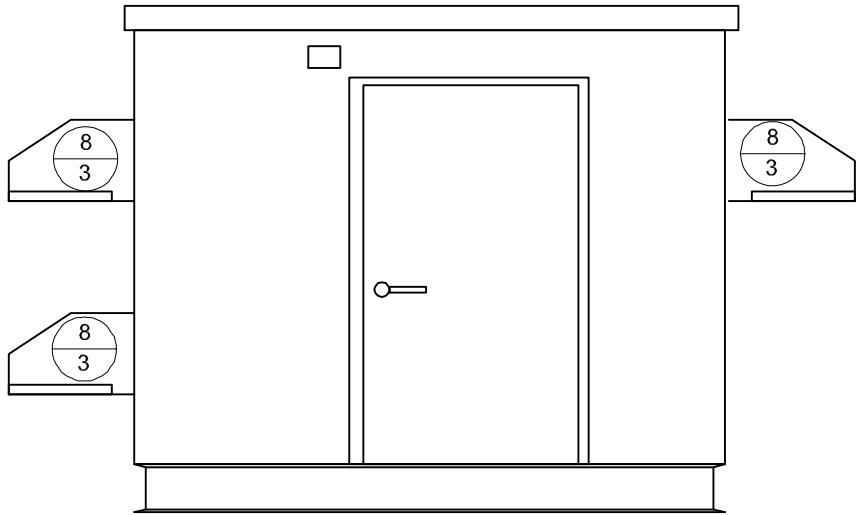

OPEN INVERTER ON SKID WITH SUN SHADE

Scale: NA

AECOM

DESIGNER

AECOM

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Solana Beach, CA 98075
858.947.7144 tel 858.947.7145 fax
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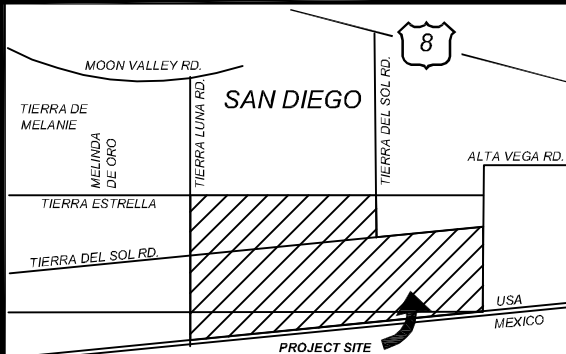
CLIENT



Soitec Solar Development, LLC

4250 Executive Square, Suite 770
San Diego, CA 92037-9178

VICINITY MAP



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FAX:
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PLOT PLAN INFORMATION

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Number of 1.36 MW Inverter Skids:	45
Total Lot Size (Acres):	Approx. 420
Estimated Disturbed Acreage:	420
Coverage Ratio:	16%

SHEET TITLE






1.36 / 2.0 MW INVERTER
BOX DESIGN

SHEET NUMBER REV.

C-130

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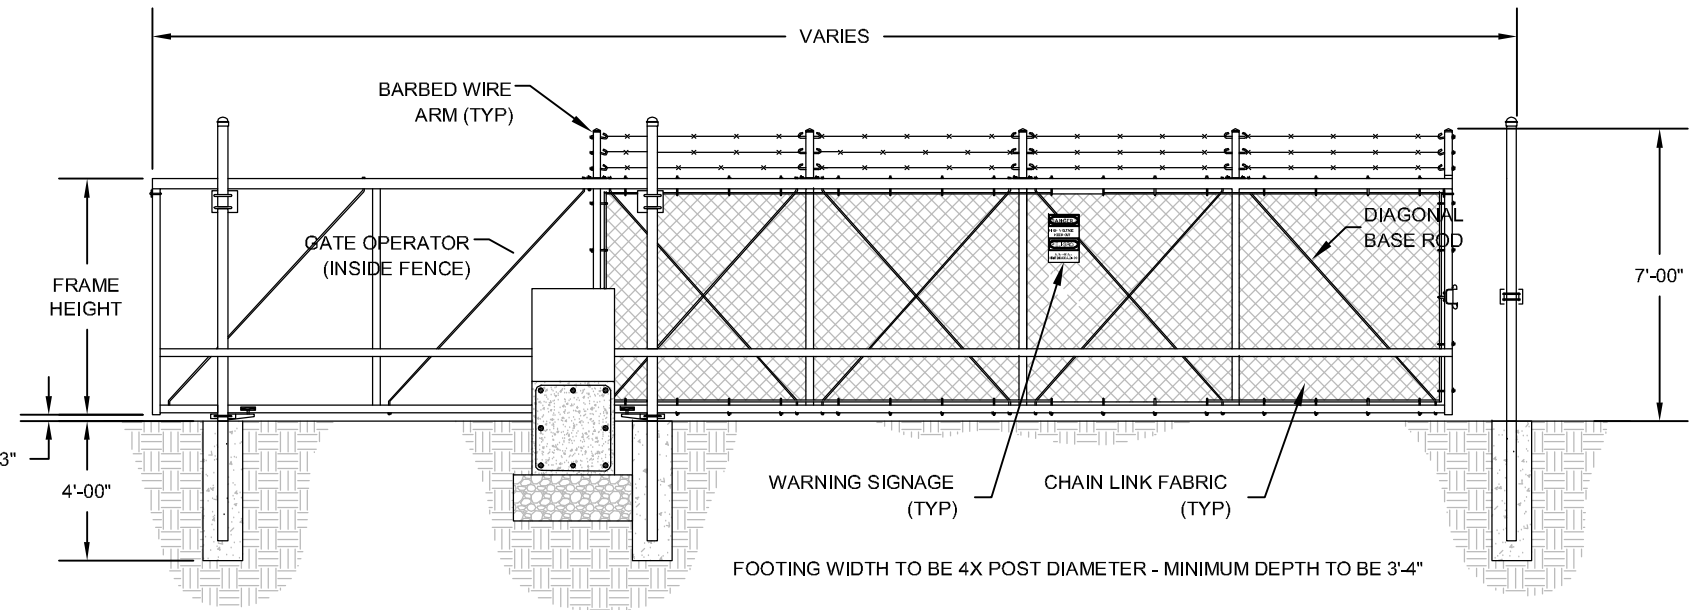
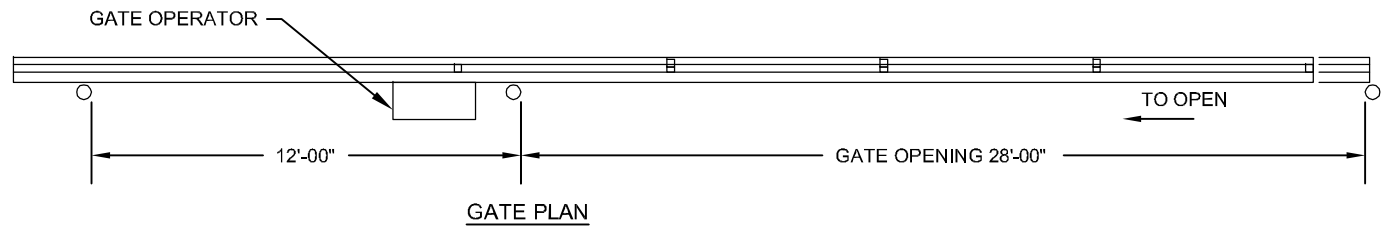
FILE NAME: P:\10 ENERGY WEST_CURRENT\NVS\OITEC SOLAR 60212653\400 TECHNICAL\401 PRELIMINARY ENGINEERING\7 PLANS - CADD FILES\ACAD SOLAR CPV LAYOUT\TIERRA DEL SOL-C-131.DWG
LAST SAVED BY: ORTIZG PLOT DATE: 8/6/2012 12:34:17 PM

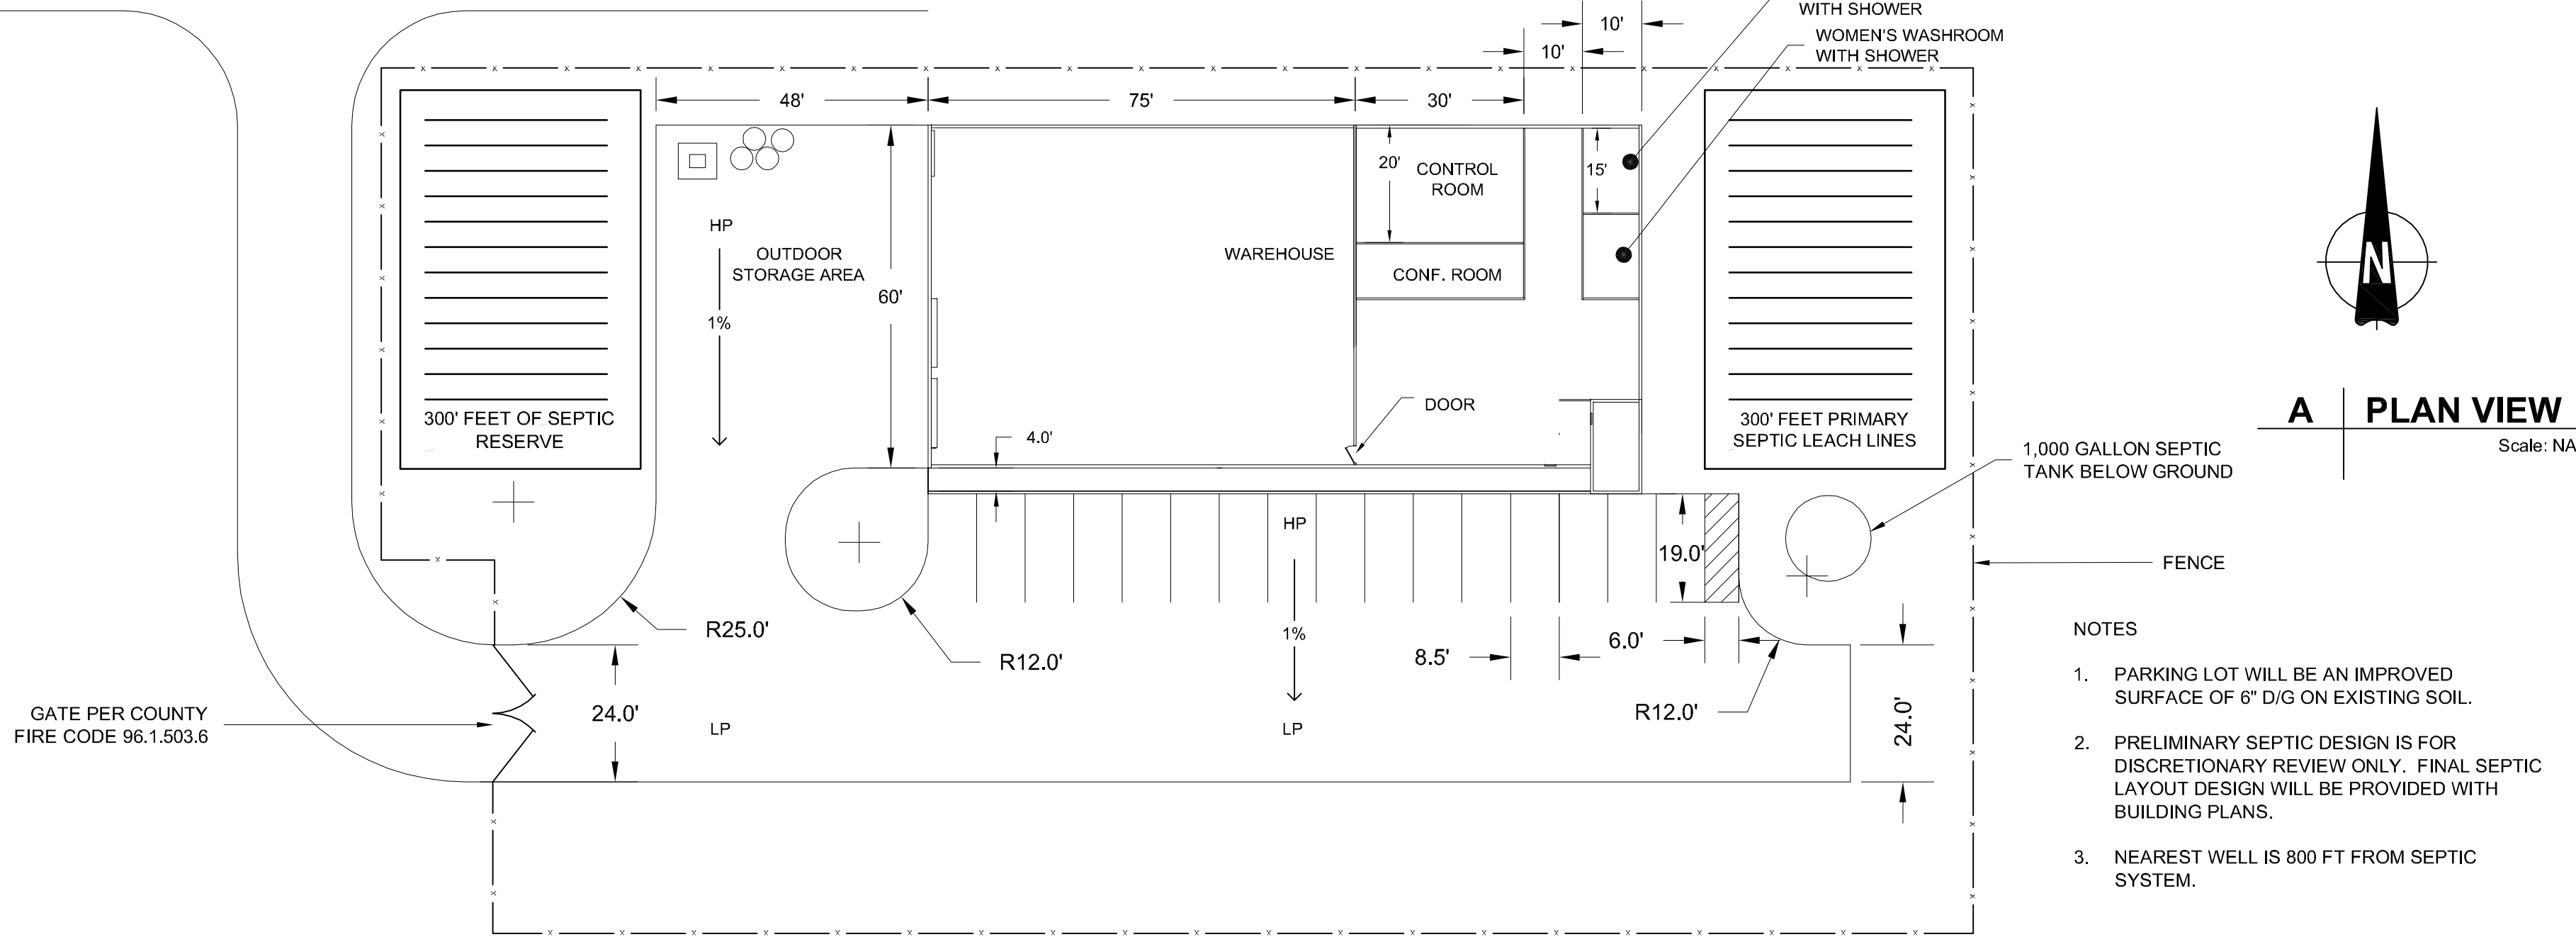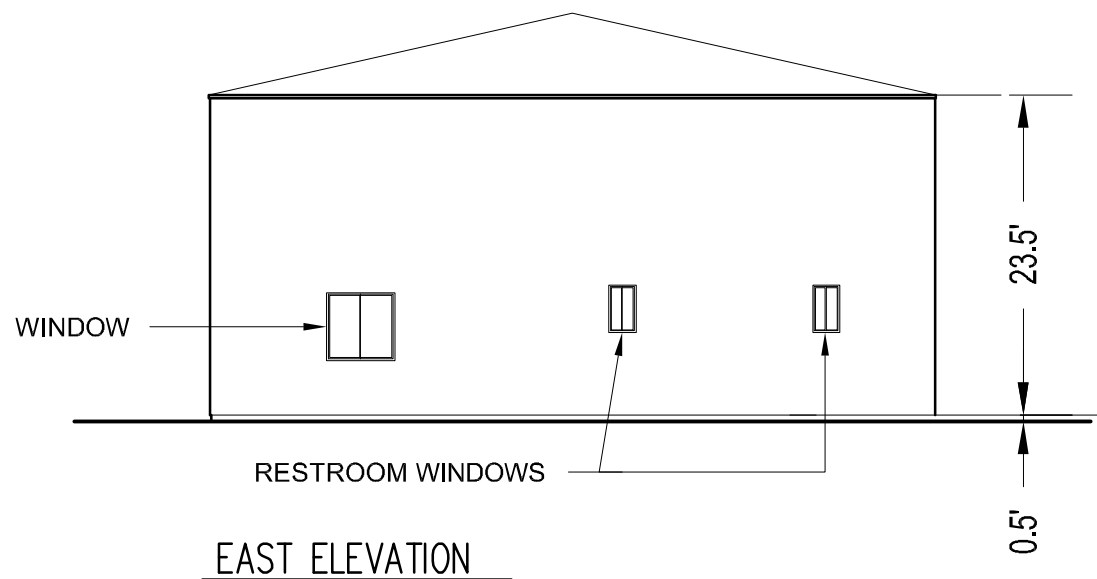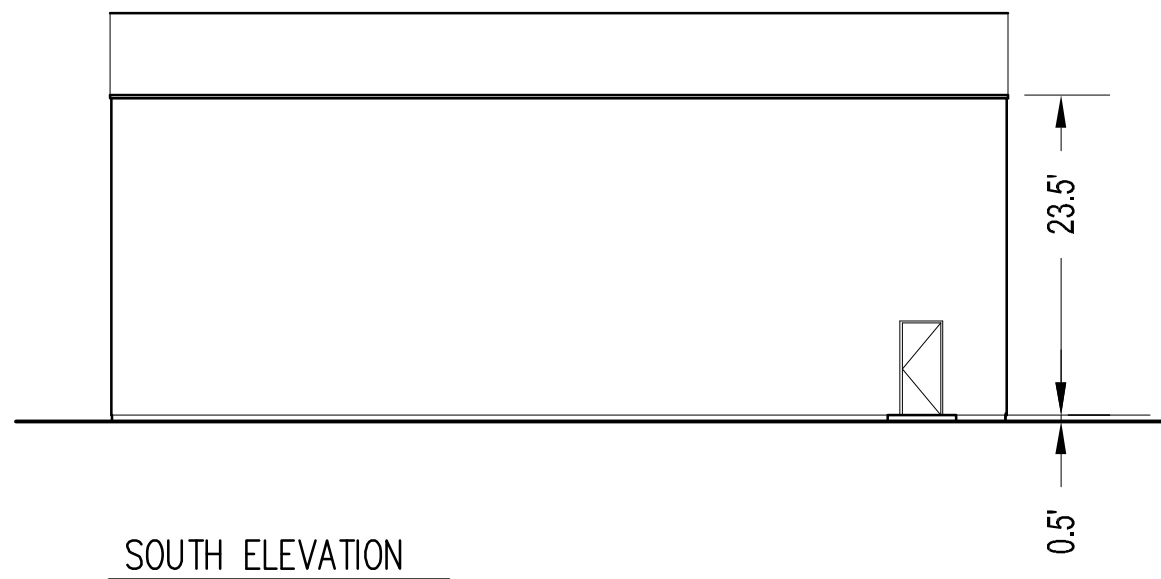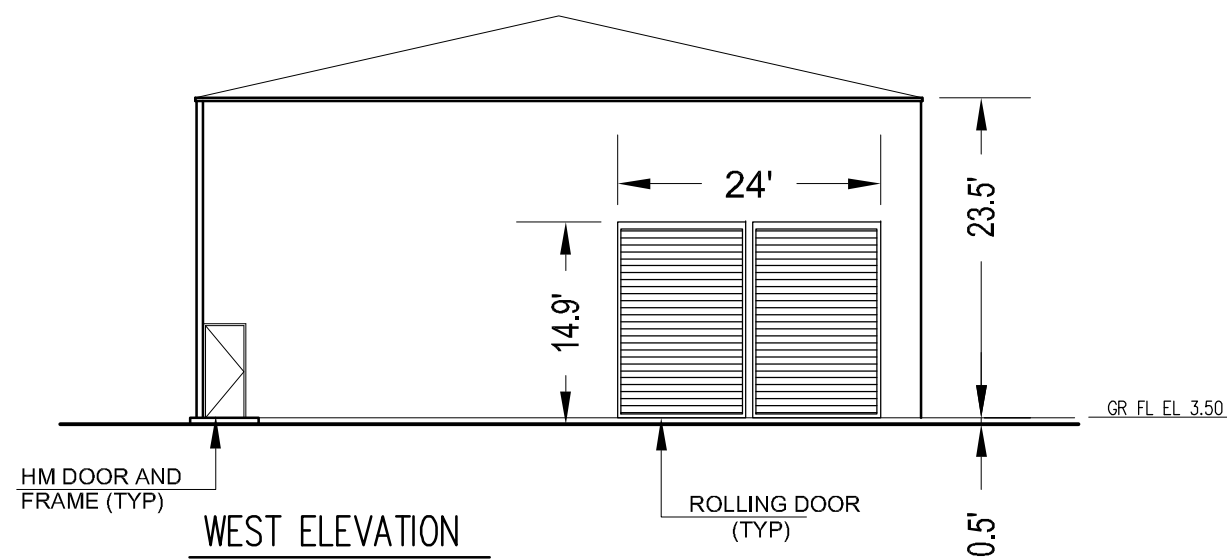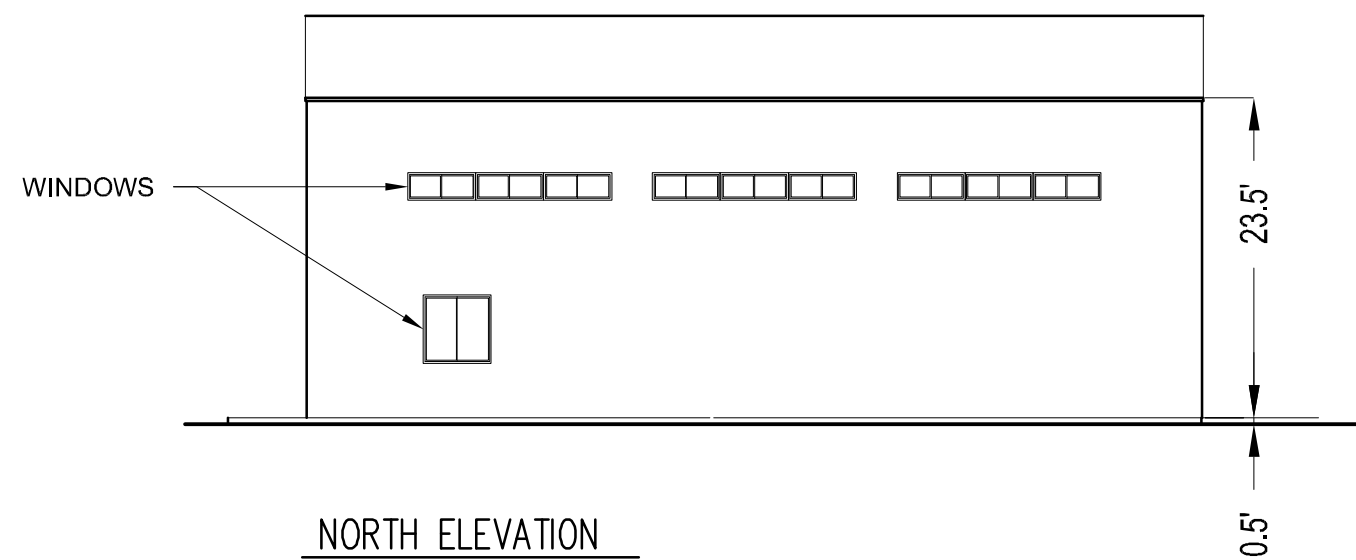

- NOTES
1. PARKING LOT WILL BE AN IMPROVED SURFACE OF 6" D/G ON EXISTING SOIL.
 2. PRELIMINARY SEPTIC DESIGN IS FOR DISCRETIONARY REVIEW ONLY. FINAL SEPTIC LAYOUT DESIGN WILL BE PROVIDED WITH BUILDING PLANS.
 3. NEAREST WELL IS 800 FT FROM SEPTIC SYSTEM.


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	STATE: TN	STATE: CA			Number of BB: 45	REV.
	ZIP: 38401	ZIP: 92037			Total AC Capacity (MWs): Approx. 60MW	C-131
	PHONE:	PHONE: (858) 652-4423			Inverter Skid AC Capacity (MWs): 1.36 / 2.0	
	FAX:	FAX:			Number of 1.36 MW Inverter Skids: 45	0
	EMAIL:	EMAIL: patrick.brown@soitec.com			Total Lot Size (Acres): Approx. 420	
					Estimated Disturbed Acreage: 420	
					Coverage Ratio: 16%	

FENCE DETAILS




1 | **DETAIL - GATE**
SINGLE MOTORIZED SLIDING GATE NTS
PER COUNTY FIRE CODE 96.1.503.6

* 4" DIAMETER POST FOR GATE LEAF LENGHT 35'-0" AND LESS

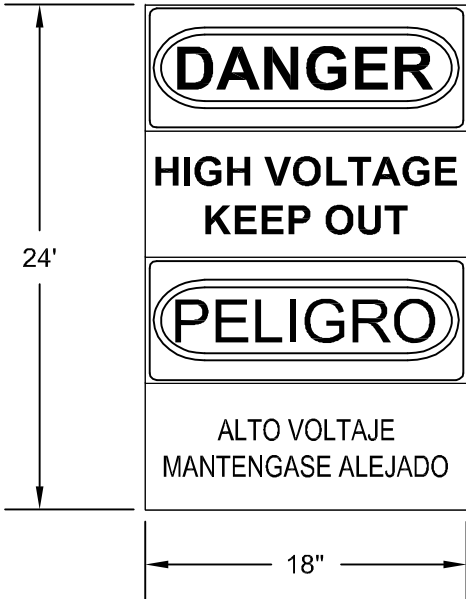

2 | **WARNING SIGNAGE**
Scale: NTS

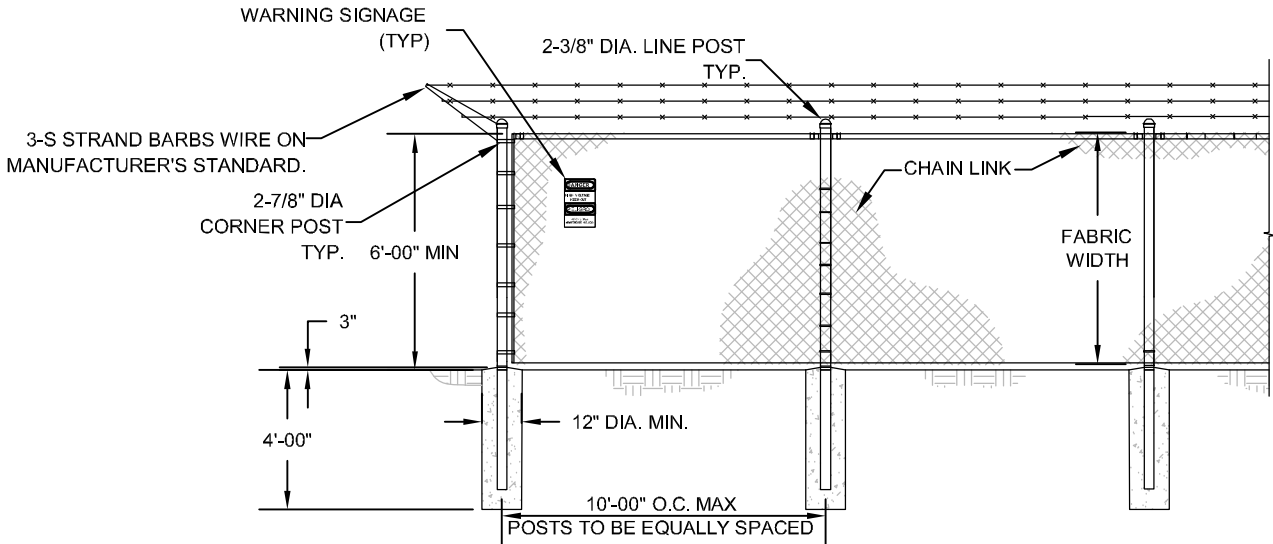

3 | **DETAIL - CHAIN LINK FENCE**
NTS

- FENCE NOTES:
- CHAIN LINK SHALL BE 2" MESH NO.9 GAGE WERE SECURITY FASTED TO LINE POSTS AND RAILS.WIRE FASTENERS AND THE CLIPS SHALL BE NO.11 GAGE
 - WIRE CONCRETE FOOTINGS SHALL HAVE TOPS CROWNED AT GROUND LEVEL.
 - CHAIN LINK FENCE TO BE FITTED WITH UV- RESISTANT MESH FABRIC, COLOR PER CUSTOMER REQUEST.
 - ELECTRICAL SAFETY SIGNAGE TO BE PLACED ALONG PERIMETER.

AECOM

DESIGNER

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CLIENT




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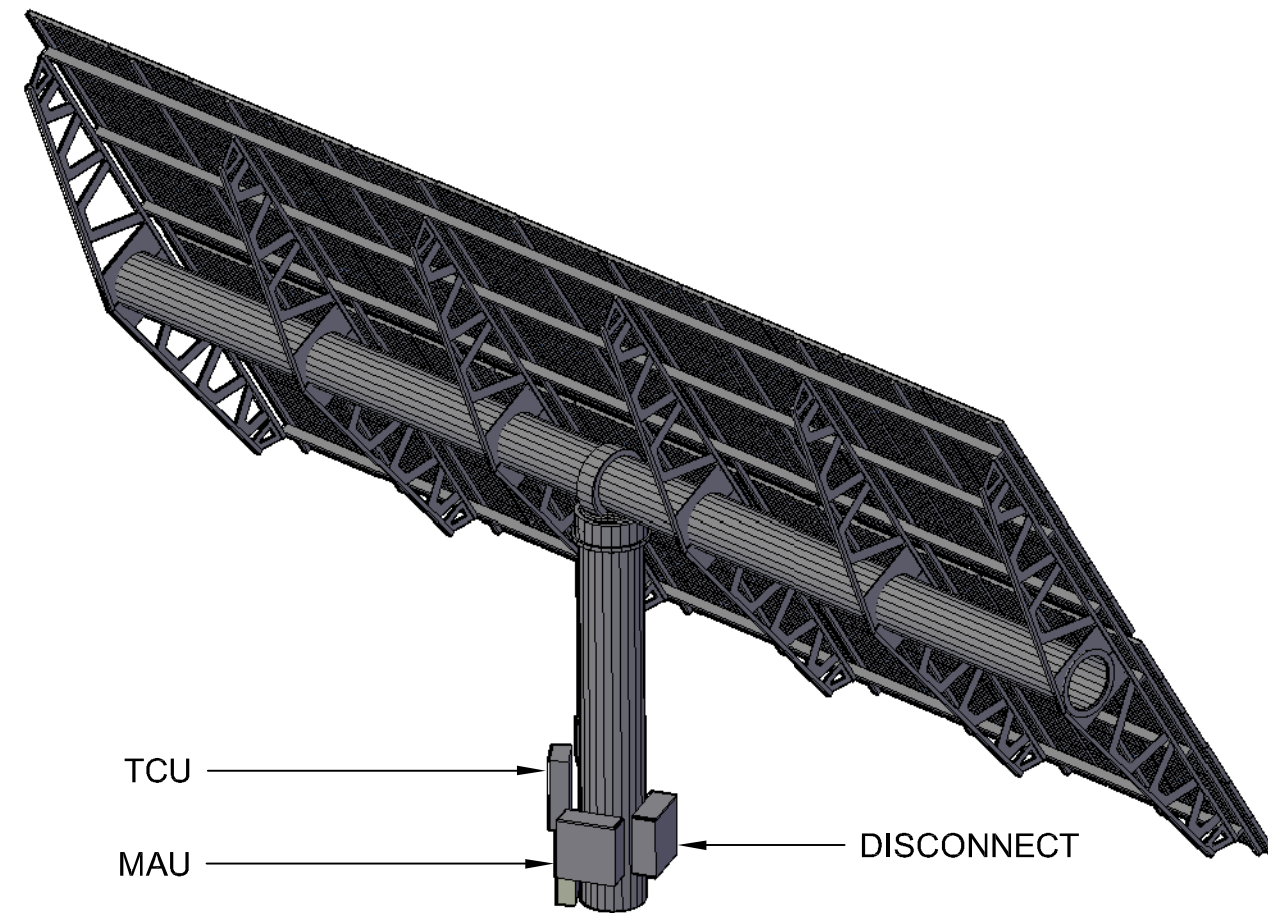
VICINITY MAP	OWNER INFORMATION	CONTACT INFORMATION	PARCEL INFORMATION	PROJECT INFORMATION	PLOT PLAN INFORMATION	SHEET TITLE
	NAME: Brown Family Trust, Brown & Reynolds Trust	NAME: Pat Brown	APN: 6580903100, 6580905500, 6581200300, 6581200200, 6580905400	EXISTING: Relatively level land on the southern and central portions of the site with rolling rock and boulder covered hills on the northwestern portion. The site is minimally developed with unpaved roads.	CPV System Summary	FENCE ELEVATION DETAIL
	ADDRESS: 1116 W. 7th Sreet PMB 158	ADDRESS: 4250 Executive Square, Suite 770	SITE ADDRESS: 796 Tierra del Sol Road, Boulevard, CA 91905	PROPOSED: 60 Megawatt (MW) project, constructed in two phases, located on approximately 420 acres and includes the construction and operation of approximately 2538 Concentrated Photovoltaic (CPV) trackers configured into 45 (1.36 MW) BB that consist of 56 trackers with associated Inverter and Transformer.	Approx. Number of Trackers: 2538	
	CITY: Columbia	CITY: La Jolla			Tracker per BB: 56	
	STATE: TN	STATE: CA			Number of BB: 45	SHEET NUMBER
	ZIP: 38401	ZIP: 92037			Total AC Capacity (MWs): Approx. 60MW	C-132
	PHONE:	PHONE: (858) 652-4423			Inverter Skid AC Capacity (MWs): 1.36 / 2.0	
	FAX:	FAX:			Number of 1.36 MW Inverter Skids: 45	0
	EMAIL:	EMAIL: patrick.brown@soitec.com			Total Lot Size (Acres): Approx. 420	
					Estimated Disturbed Acreage: 420	
					Coverage Ratio: 16%	

FILE NAME: P:\10 ENERGY WEST_CURRENT\VIS\SOITEC SOLAR 60212653\400 TECHNICAL\401 PRELIMINARY ENGINEERING\7 PLANS - CADD FILES\ACAD SOLAR CPV LAYOUT\TIERRA DEL SOL-C-133 CPV TRACKER.DWG
LAST SAVED BY: ORTIZG PLOT DATE: 8/6/2012 10:05:42 AM




1 | STOW MODE VIEW

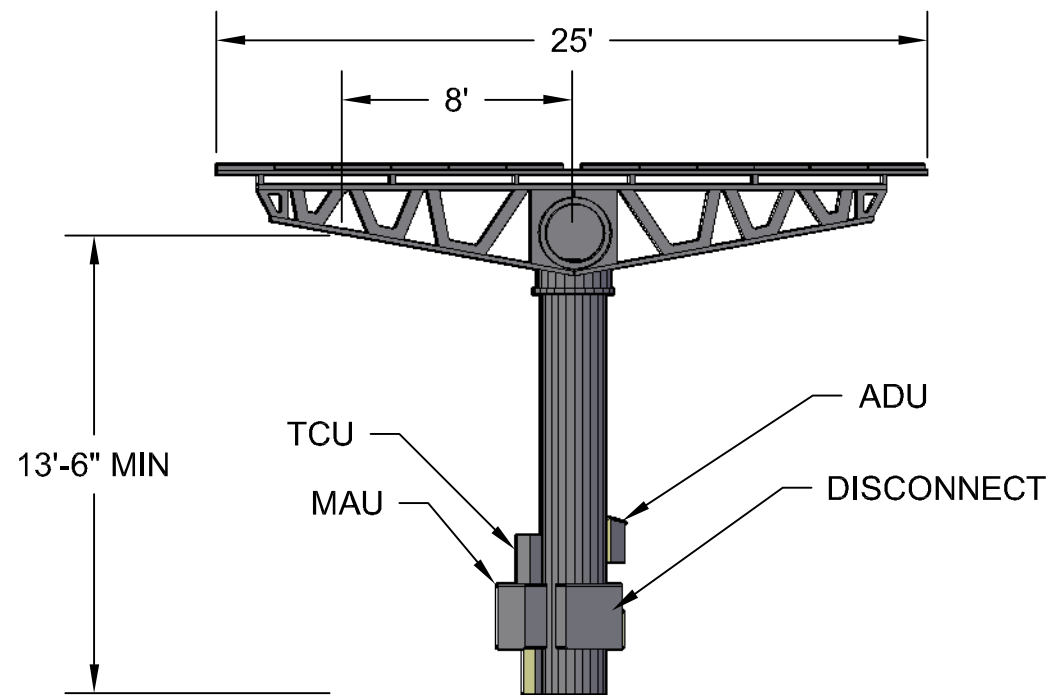Scale: NA




2 | ISOMETRIC VIEW

Scale: NA

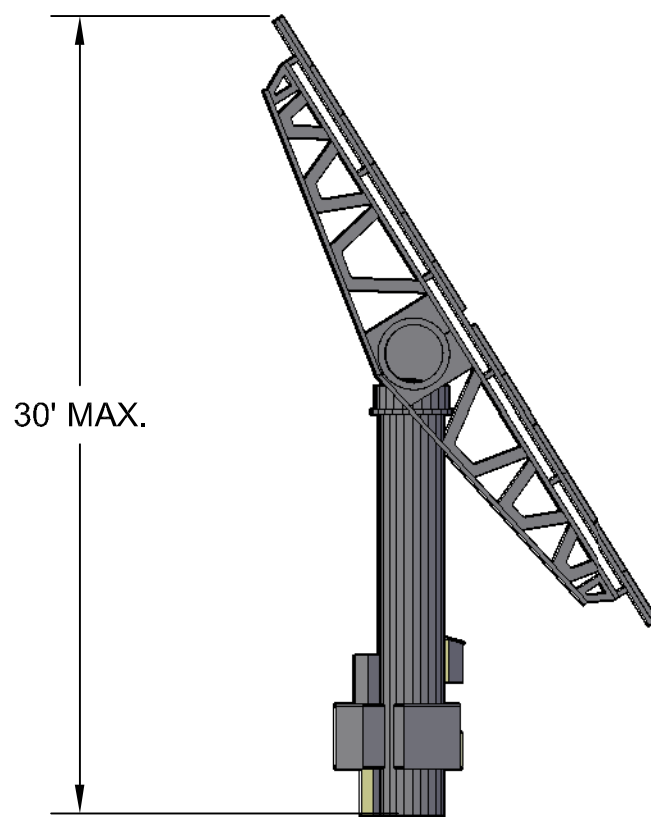

3 | SIDE VIEW

Scale: NA

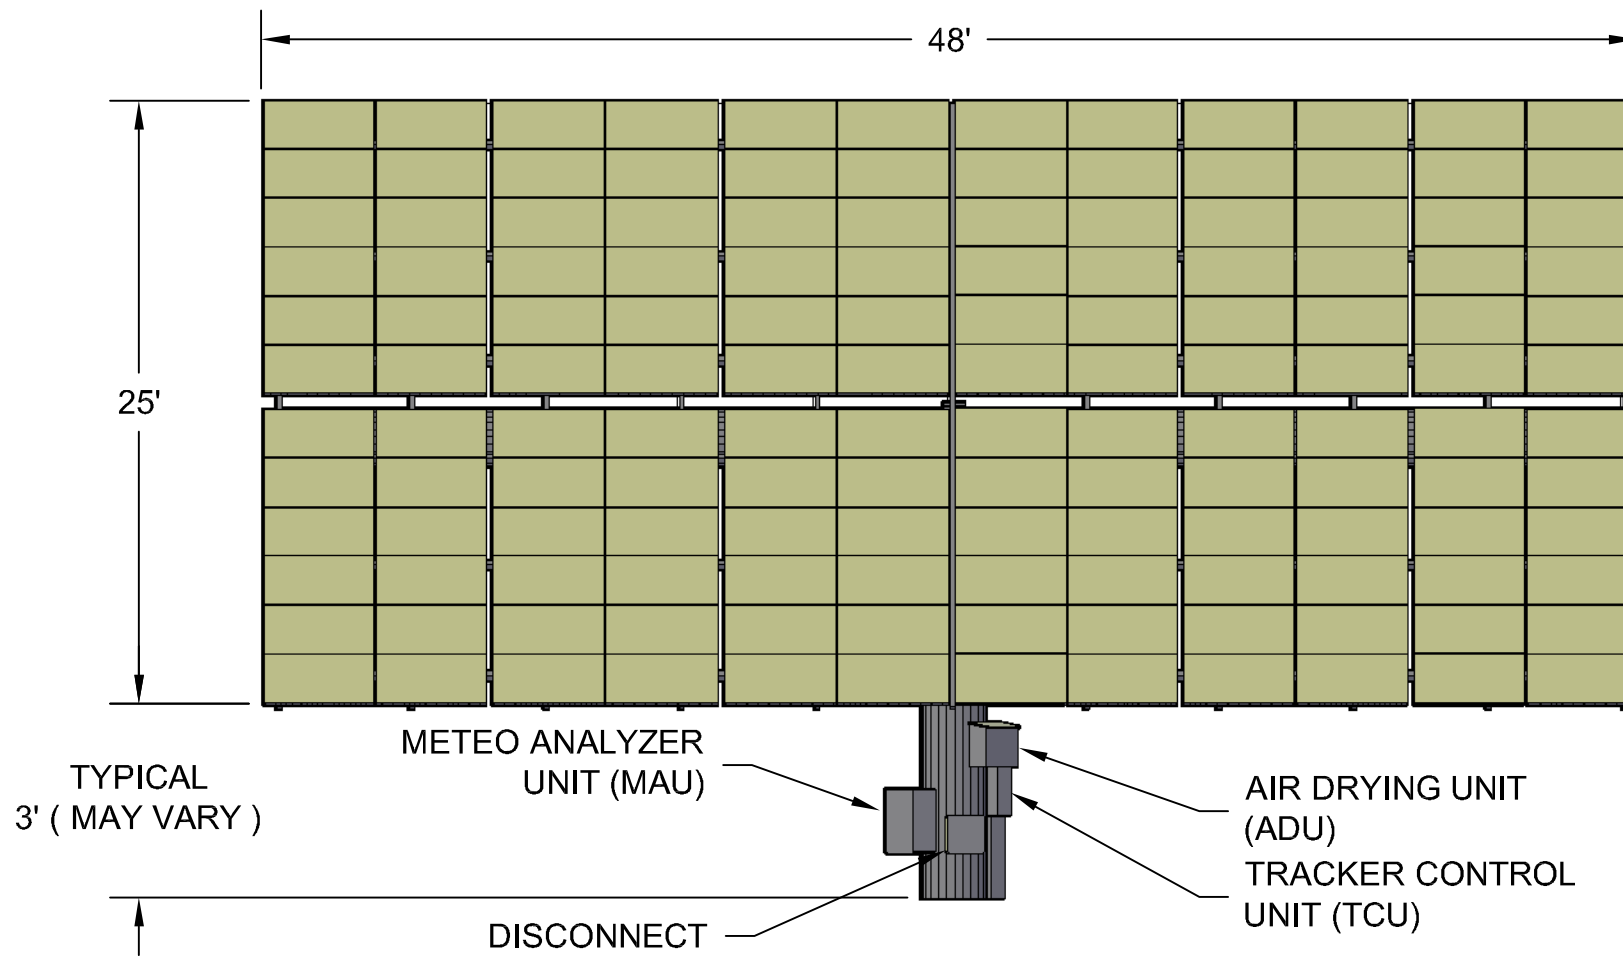

4 | FRONT VIEW

Scale: NA

PRELIMINARY,
NOT FOR CONSTRUCTION

VICINITY MAP	OWNER INFORMATION	CONTACT INFORMATION	PARCEL INFORMATION	PROJECT INFORMATION	PLOT PLAN INFORMATION	SHEET TITLE
	NAME: Brown Family Trust, Brown & Reynolds Trust	NAME: Pat Brown	APN: 6580903100, 6580905500, 6581200300, 6581200200, 6580905400	EXISTING: Relatively level land on the southern and central portions of the site with rolling rock and boulder covered hills on the northwestern portion. The site is minimally developed with unpaved roads.	CPV System Summary	TRACKER ELEVATION DETAIL
	ADDRESS: 1116 W. 7th Sreet PMB 158	ADDRESS: 4250 Executive Square, Suite 770	SITE ADDRESS: 796 Tierra del Sol Road, Boulevard, CA 91905	PROPOSED: 60 Megawatt (MW) project, constructed in two phases, located on approximately 420 acres and includes the construction and operation of approximately 2538 Concentrated Photovoltaic (CPV) trackers configured into 45 (1.36 MW) BB that consist of 56 trackers with associated Inverter and Transformer.	Approx. Number of Trackers: 2538	
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	ZIP: 38401	ZIP: 92037			Total AC Capacity (MWs): Approx. 60MW	C-133
	PHONE:	PHONE: (858) 652-4423			Inverter Skid AC Capacity (MWs): 1.36 / 2.0	
	FAX:	FAX:			Number of 1.36 MW Inverter Skids: 45	0
	EMAIL:	EMAIL: patrick.brown@soitec.com			Total Lot Size (Acres): Approx. 420	
					Estimated Disturbed Acreage: 420	
					Coverage Ratio: 16%	

AECOM

DESIGNER

AECOM

AECOM TECHINCAL SERVICES, INC
440 Stevens Avenue, Suite 250
Solana Beach, CA 98075
858.947.7144 tel 858.947.7145 fax
www.aecom.com


CLIENT



Soitec Solar Development, LLC

4250 Executive Square, Suite 770
San Diego, CA 92037-9178

FILE NAME: P:\10 ENERGY WEST_CURRENT\NVS\SOITEC SOLAR 60212653\400 TECHNICAL\401 PRELIMINARY ENGINEERING\7 PLANS - CADD FILES\ACAD SOLAR CPV LAYOUT\TIERRA DEL SOL-C-134 WATER TANK.DWG
LAST SAVED BY: ORTIZG PLOT DATE: 8/3/2012 1:28:28 PM

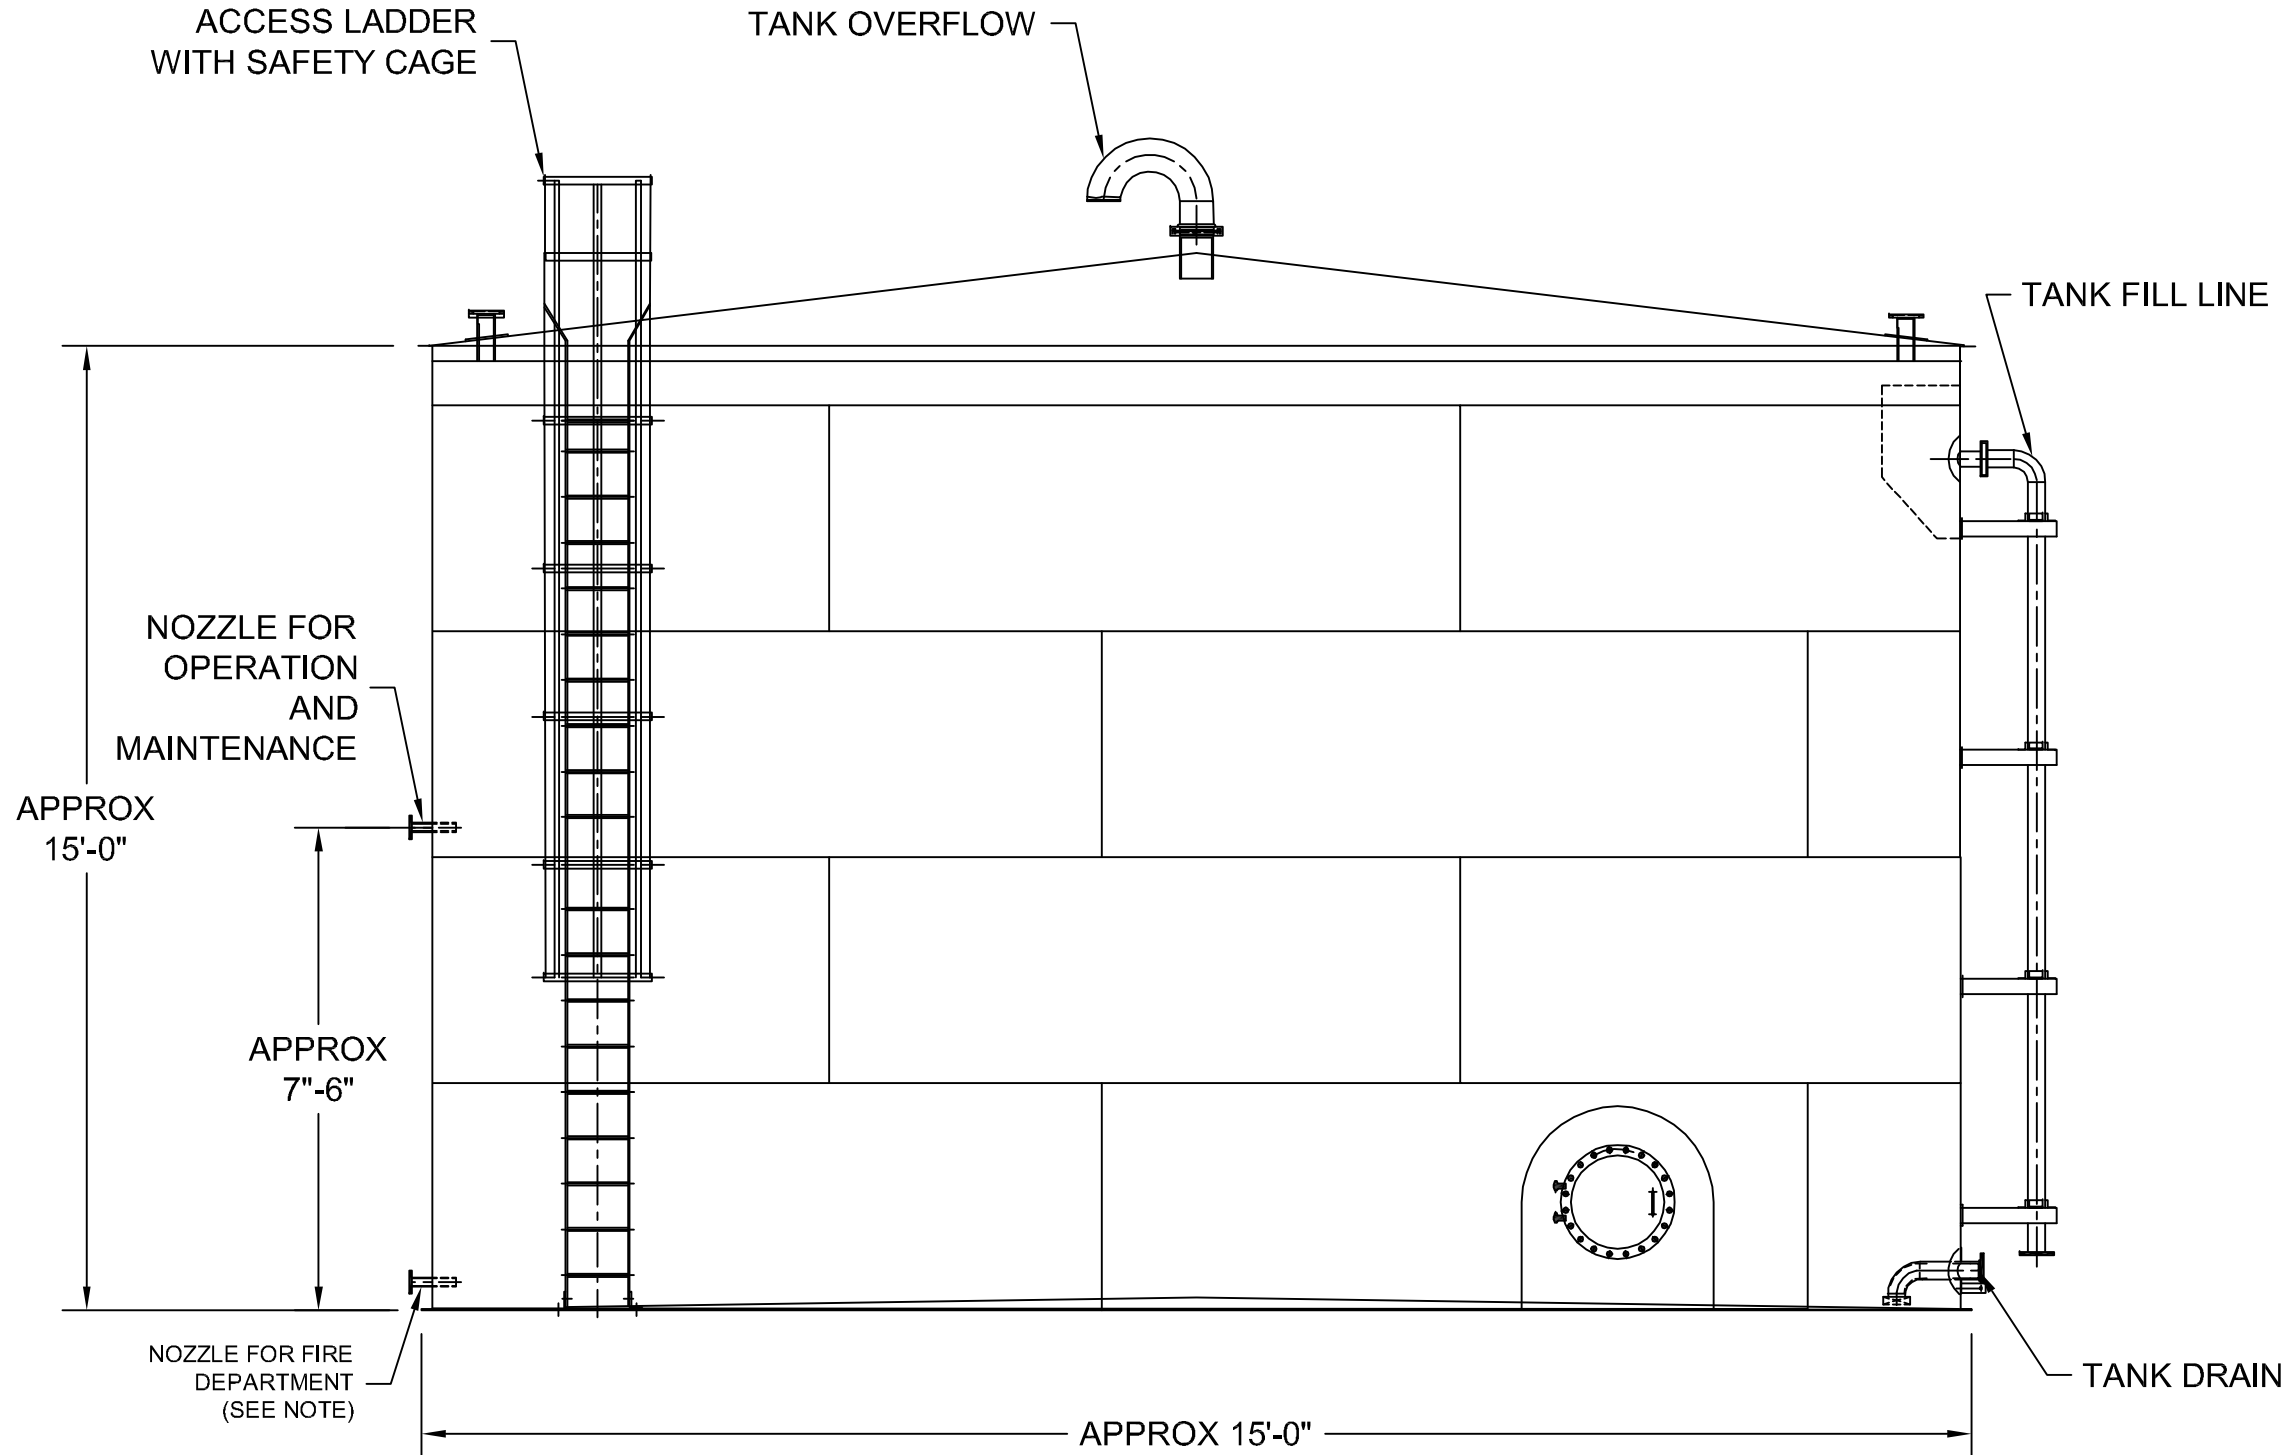


NOTE:

- IN ACCORDANCE WITH SECTION 507.2.2 IN TITLE 9, DIVISION 6, CHAPTER 1 OF THE SAN DIEGO COUNTY CODE:
1. THE SUPPLY OUTLET SHALL BE AT EAST 4 INCHES IN DIAMETER FROM THE BASE OF THE TANK TO THE POINT OF OUTLET AT THE FIRE DEPARTMENT CONNECTION. THE FIRE DEPARTMENT CONNECTION SHALL BE AT LEAST ONE 4-INCH NATIONAL STANDARD THREAD (MALE), REDUCE TO ONE 2½ INCH NATIONAL STANDARD THREAD (MALE). ADDITIONAL OUTLETS MAY BE REQUIRED.
 2. THE LOCATION OF THE FIRE DEPARTMENT OUTLET TO BE DETERMINED ON THE PLOT PLAN WHEN SUBMITTED TO THE FIRE DEPARTMENT. CONSIDERATION WILL BE GIVEN TO TOPOGRAPHY, ELEVATIONS, AND DISTANCE FROM STRUCTURES, DRIVEWAY ACCESS, PREVAILING WINDS, ETC.
 3. THE OUTLET SHALL BE LOCATED ADJACENT TO THE FIRE ACCESS ROAD.

1 **DETAIL - WATER TANK**

Scale: NTS

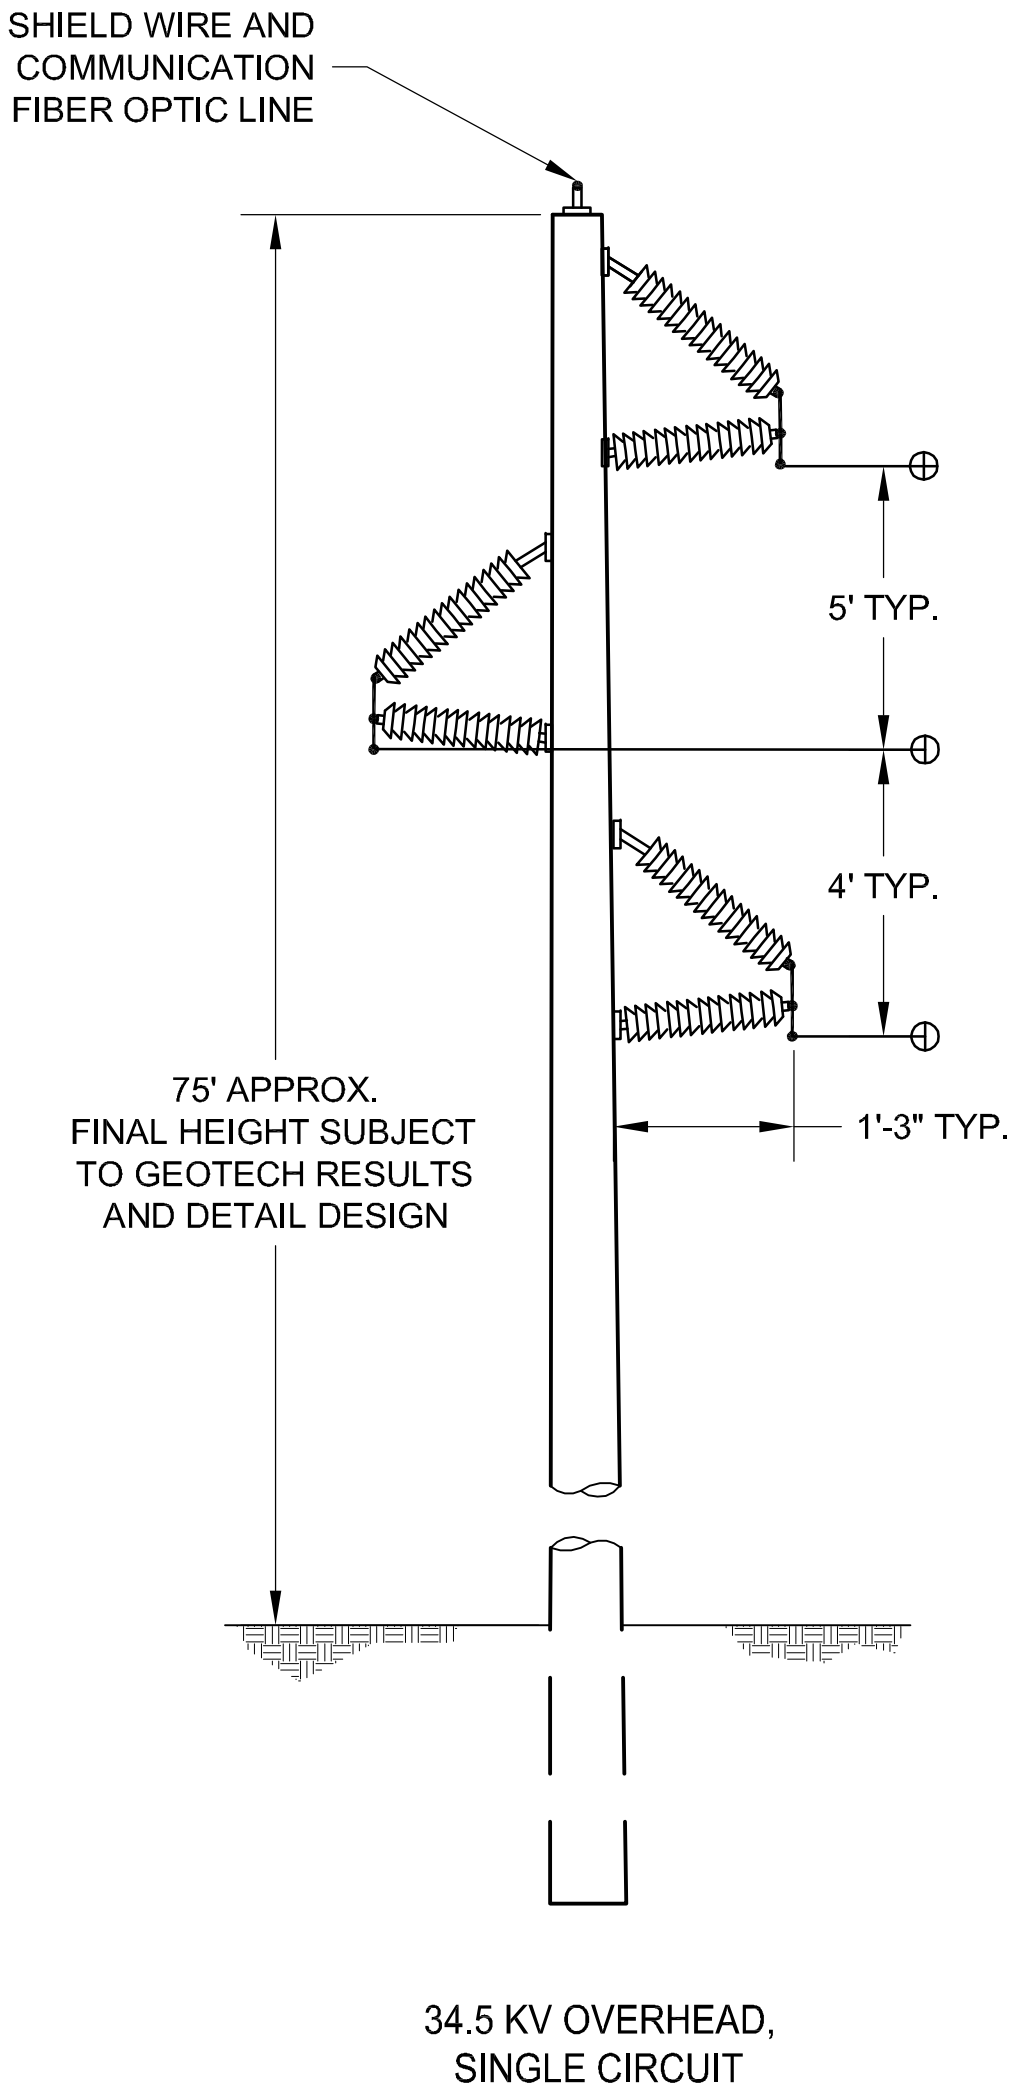

2 **DETAIL - TRANSMISSION POLE**

Scale: NTS

**PRELIMINARY,
NOT FOR CONSTRUCTION**

AECOM

DESIGNER

AECOM


AECOM TECHINCAL SERVICES, INC
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858.947.7144 tel 858.947.7145 fax
www.aecom.com

CLIENT



Soitec Solar Development, LLC

4250 Executive Square, Suite 770
San Diego, CA 92037-9178

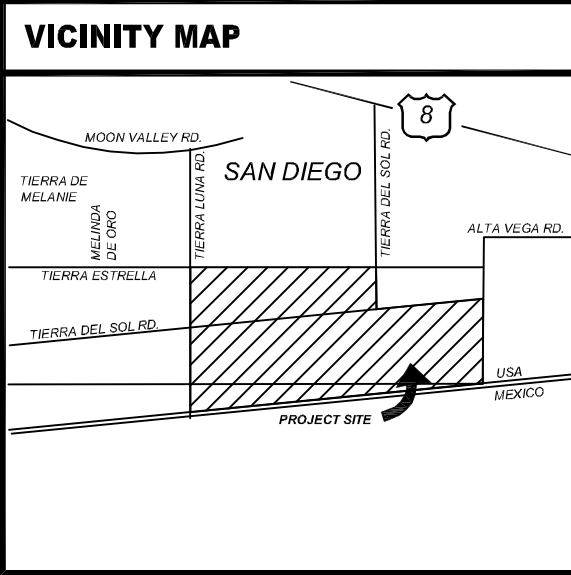

OWNER INFORMATION	
NAME:	Brown Family Trust, Brown & Reynolds Trust
ADDRESS:	1116 W. 7th Sreet PMB 158
CITY:	Columbia
STATE:	TN
ZIP:	38401
PHONE:	
FAX:	
EMAIL:	

CONTACT INFORMATION	
NAME:	Pat Brown
ADDRESS:	4250 Executive Square, Suite 770
CITY:	La Jolla
STATE:	CA
ZIP:	92037
PHONE:	(858) 652-4423
FAX:	
EMAIL:	patrick.brown@soitec.com

PARCEL INFORMATION	
APN:	6580903100, 6580905500, 6581200300, 6581200200, 6580905400
SITE ADDRESS:	796 Tierra del Sol Road, Boulevard, CA 91905

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PLOT PLAN INFORMATION	
CPV System Summary	
Approx. Number of Trackers:	2538
Tracker per BB:	56
Number of BB:	45
Total AC Capacity (MWs):	Approx. 60MW
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Number of 1.36 MW Inverter Skids:	45
Total Lot Size (Acres):	Approx. 420
Estimated Disturbed Acreage:	420
Coverage Ratio:	16%

SHEET TITLE	
WATER TANK & 34.5kV OVERHEAD ELEVATION DETAL	
SHEET NUMBER	REV.
C-134	0